



UNITED STATES MARINE CORPS
MARINE CORPS BASE
CAMP LEJEUNE, NORTH CAROLINA 28542

P-178

IN REPLY REFER TO
MCEX/ANW/es
7100

MAR 29 1977


From: Commanding General
To: Commandant of the Marine Corps (Code LFF), Headquarters, U. S.
Marine Corps, Washington, D. C. 20380

Subj: Documentation of Projects submitted on MCX Form-495 as Five-
Year Long Range Major Improvement Facility Program for MCX 5-1

- Encl: (1) Documentation for Location Exchange Areas 1 and 2,
Project #P-178
(2) Documentation for Location Exchange Courthouse Bay Area,
Project #P-416
(3) Documentation for Location Exchange Areas 4 and 5,
Project #P-724
(4) DD Form 1391 for FY-80 Project P-063 (French Creek Area
Location Exchange)
(5) DD Form 1391 for FY-80 Project P-603 (Marine Corps Air
Station (Helicopter), New River and Camp Geiger Area Exchange
Service Station)


Ref: (a) MCO P11000.12A
(b) Head MCX Serv Memo LFE-dar of 29 Dec 1976 (Nota1)

1. The documentation required by reference (a) and as modified by
reference (b), pertaining to the Five Year Long Range Major Improvement
Facilities Program of this Exchange ~~is~~ forwarded as enclosures (1)
through (5).

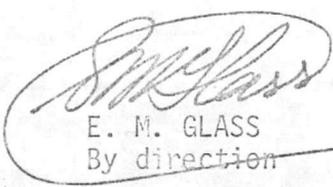
E. M. GLASS
By direction

Copy to:
CMC (Code LFE)

~~ENCLOSURE~~

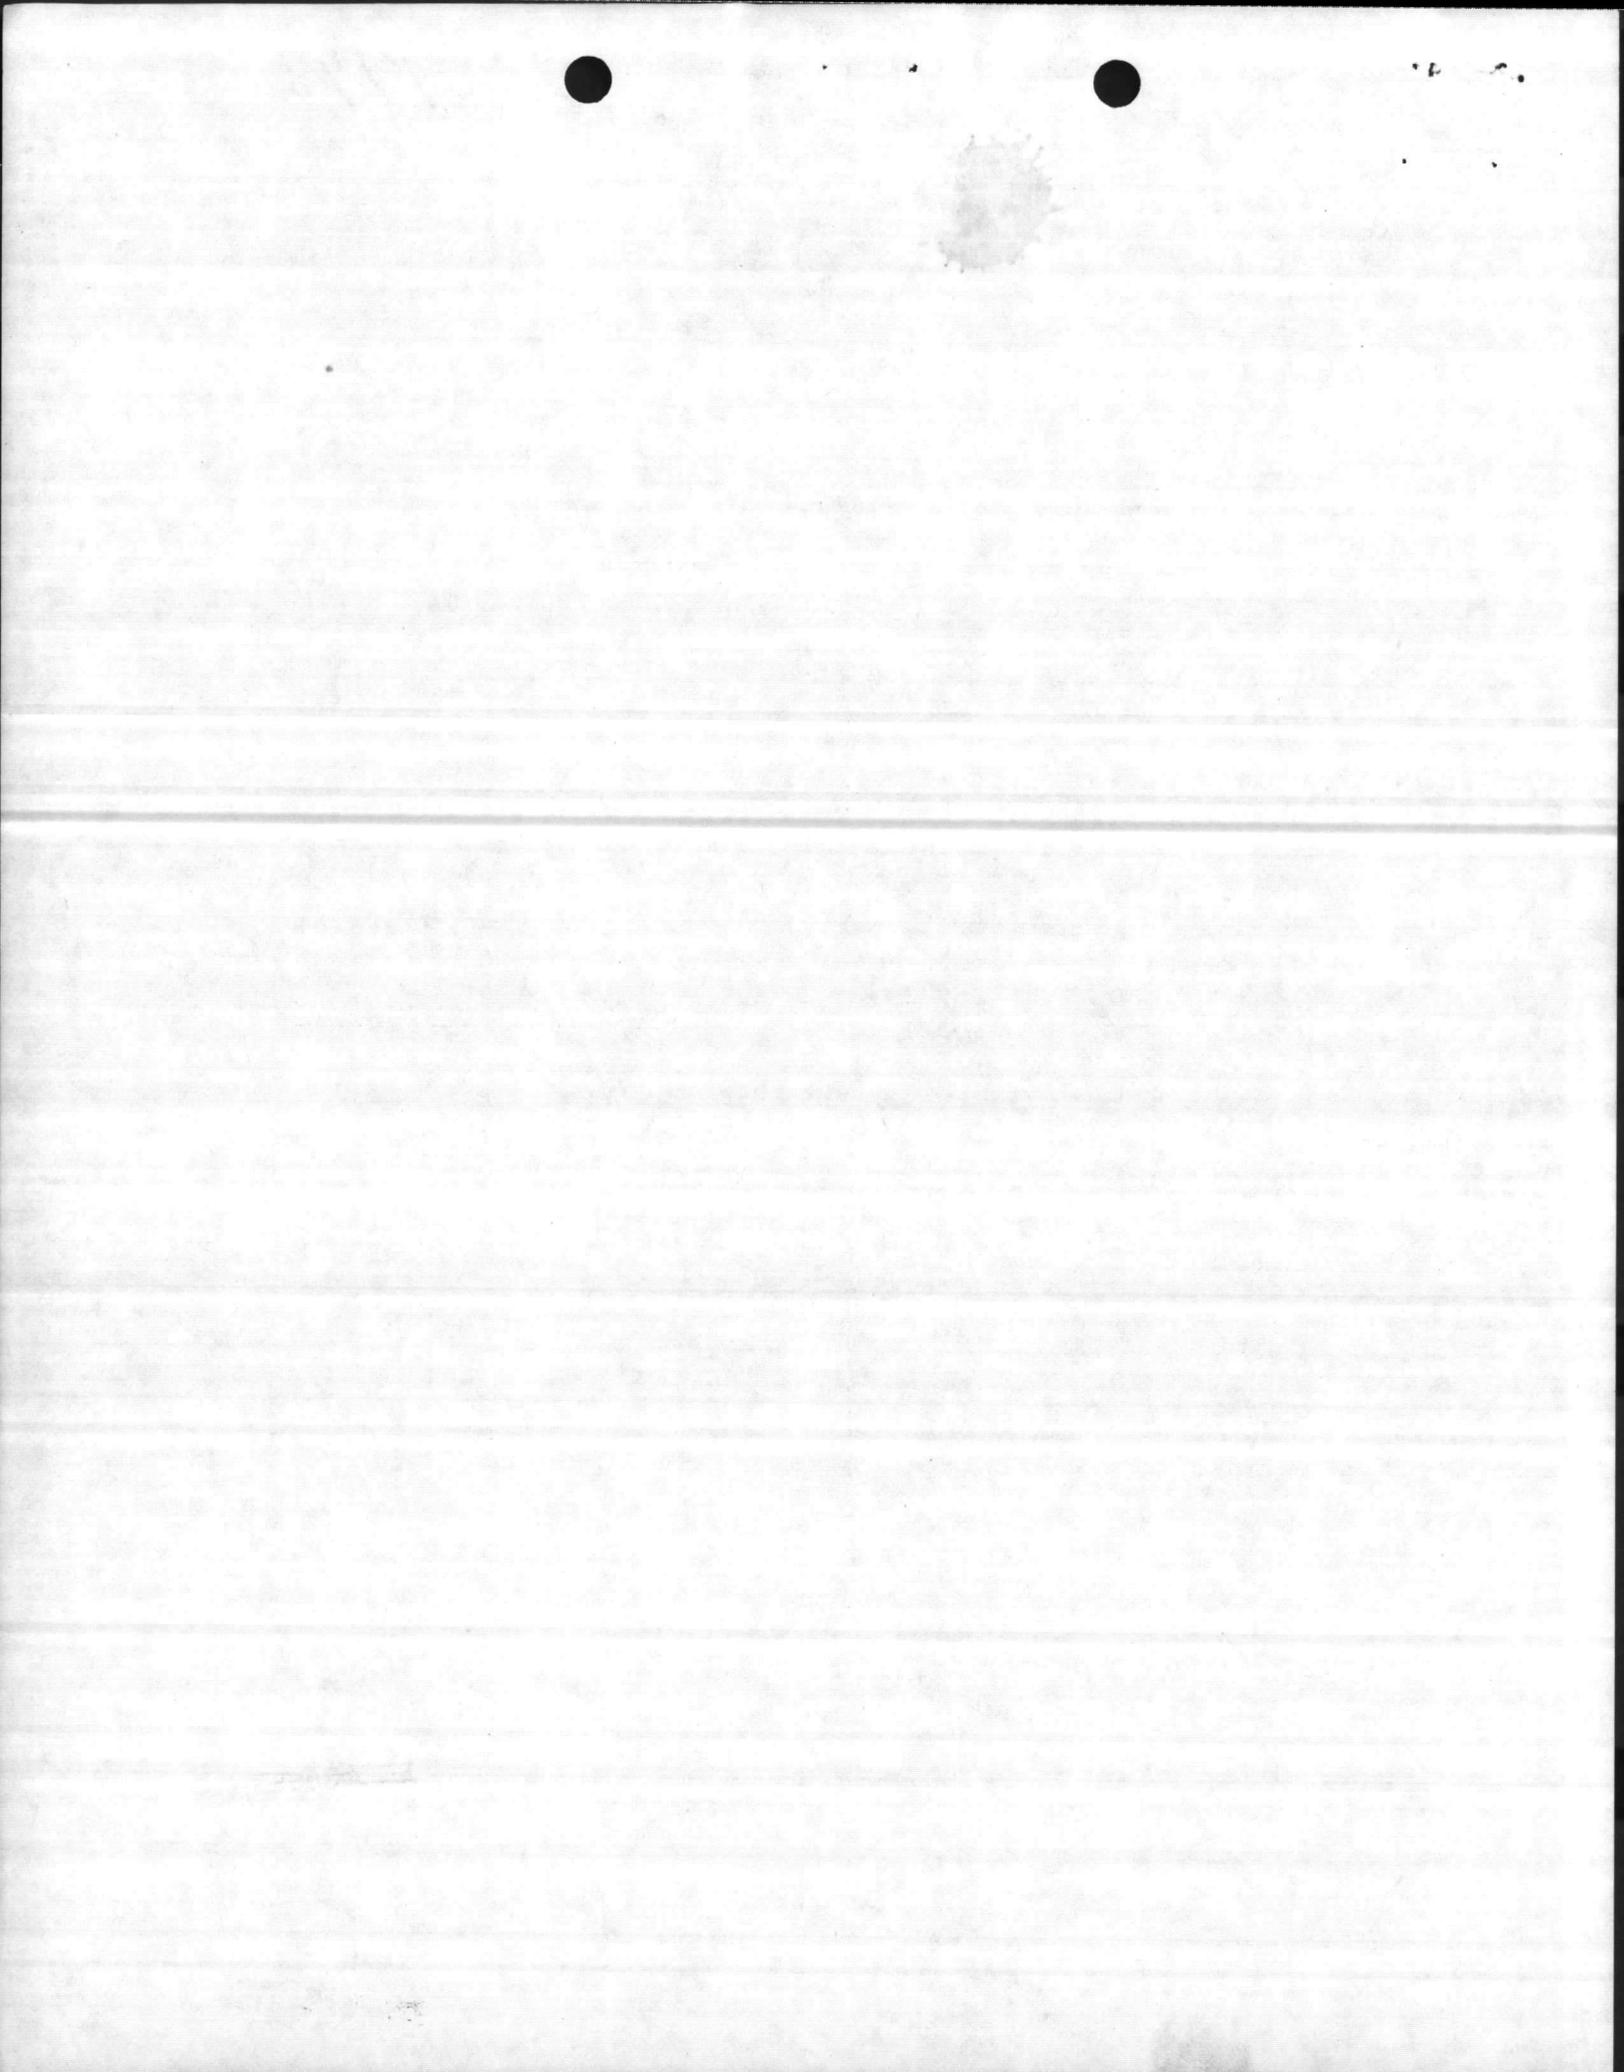

PROJECT EVALUATION SHEET

Date: 29 March 77

A. Exchange Marine Corps Base, Camp Lejeune, North Carolina
 Location

B. Project Exchange 1 & 2, # P-178, FY 1978

C. Project Category 99

D. Appropriate Facility Documentation Submitted X Yes No

E. Capital Expenditure

1. Cost of construction project	<u>507,064</u>	
2. Cost of <u>new</u> collateral equipment	<u>72,500</u>	
3. Cost of replacement collateral equipment	<u>50,000</u>	
4. Total cost of project		<u>629,564</u>
5. Cost of project to be funded through CCF (4 less 3)		<u>579,564</u>

F. Estimated increase in monthly sales 57,885

G. Estimated increase in monthly direct operating profit 4,573

H. Estimated amortization schedule in months (Item 4 divided by increase in operating profit) 137

I. Brief description of project


Construct a consolidated Exchange in the Hadnot Point Area 1 & Area 2, provide facilities for snack bar, retail store, barber shop and dry cleaning pick up station. Building to be approximately 14,400 square feet.

J. Justification criterion applicable (include more than one criterion if applicable).

To improve customer service through consolidation of activities.

K. Priority classification of this project is number 2 of 2 for projects submitted by this exchange for FY 1978.

ENCLOSURE (1)

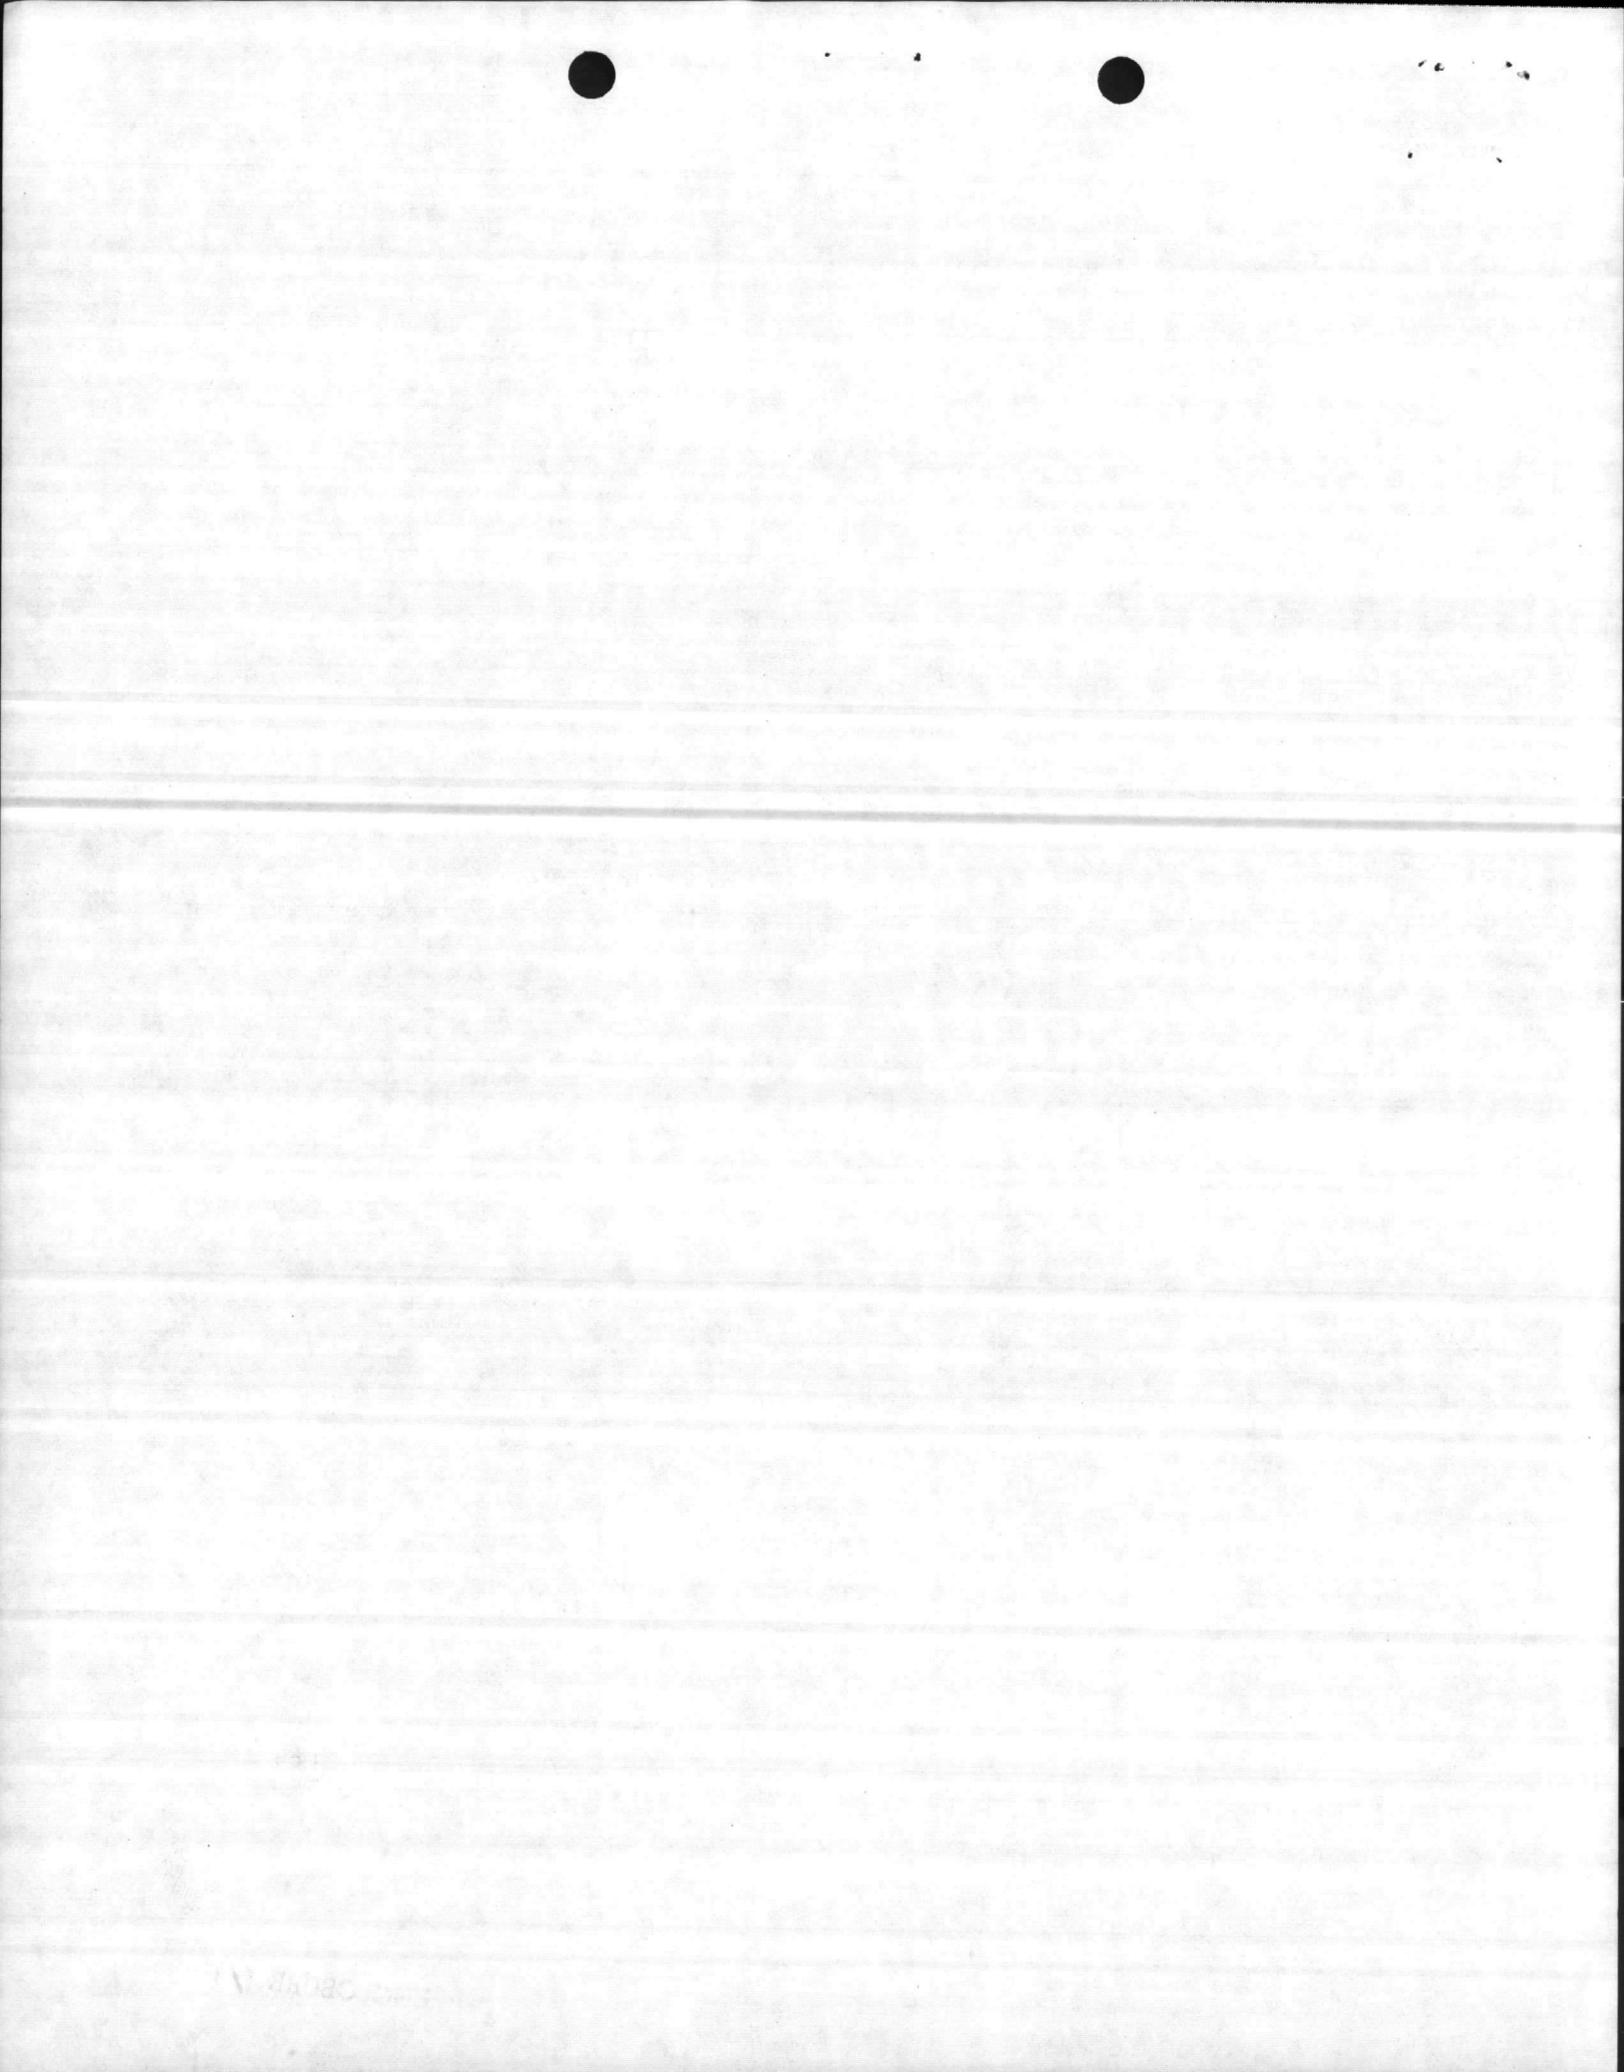


IDENTIFICATION NUMBER

P-178

AREA OR NO	ACTIVITY	LOCATION	CATEGORY CODE NUMBER
5th ND	MARINE CORPS BASE	CAMP LEJEUNE, NORTH CAROLINA	740-02
PROJECT (Or Line Item) TITLE			

Location Exchange Area 1 & 2

ITEM (OR FEATURE) DESCRIPTION (Abbreviate if necessary)	QUANTITIES		MATERIAL COSTS		LABOR COSTS		ENGINEERING ESTIMATE	
	NO. OF UNITS	UNIT	UNIT COST	COST	UNIT COST	COST	UNIT COST	COST
1	2	3	4	5	6	7	8	9
BRICK	79,500	EA	.12	9,540	37	29,415	49	38,955
6" CMU W/INSULATION	5,000	EA	.43	2,150	1.00	5,000	1.43	7,150
BAR JOISTS	10	TN	550	5,500	130	1,300	680	6,800
STRUCTURAL STL.	12	TN	560	6,720	140	1,680	700	8,400
4" Ø PIPE STL COL	2,000	LB	30	600	.08	160	38	760
METAL ROOF DECK	14,400	SF	.60	8,640	.45	6,480	1.05	15,120
BUILT-UP-ROOF	144	SF	35	5,040	21	3,024	56	8,064
COPPER FLASHING	1,060	SF	1.70	1,802	1.15	1,219	2.85	3,021
2" RIGID INSULATION	14,400	SF	30	4,320	.15	2,160	45	6,480
VINYL ASH. TILE	6,000	SF	75	4,500	.32	1,920	1.07	6,420
HEUGATILE FLOOR	8,000	SF	1	8,000	.65	5,200	1.65	13,200
ACOUSTICAL TILE SUSPEND	14,400	SF	80	11,520	45	6,480	1.25	18,000
DBL. ENTR. ALUM. DR. FRAMES & HARDWARE	4	EA	800	3,200	115	460	915	3,660
DBL. EXTERIOR HOLLOW STL. DR. FRAME & HDWE.	4	EA	480	1,920	180	720	660	2,640
INT. HOLLOW DOOR COMP.	9	EA	135	1,215	85	765	220	1,980
INT. WALL PARTITIONS	447	LF	170	7,800		4,500		12,300
METAL TOILET STALLS	12	EA	170	2,040	56	672	226	2,712
METAL DOWNSPOUT	280	LF	4.65	1,302	60	168	5.25	1,470
METAL SCUPPERS	20	EA	56	1,120	20	400	76	1,520
6' WIDE ALUM. CANOPY	190	LF	9.25	1,758	6.45	1,226	15.70	2,984
PAINING	8,000	SF	12	960	30	2,400	42	3,360
ELECTRICAL								
400 AMP PANEL								
LGT PANEL CRT BKR ETC.	5	EA	730	3,650	120	600	850	4,250
4 TUBE RECESSED FLR. LIGHTS	150	EA	85	12,750	17	2,550	102	15,300
ELEC. RECEPTACLES	100	EA	4.50	450	6.75	675	11.25	1,125
MERCURY VAPOR OUTSIDE LIGHT W/POLE	12	EA	210	2,520	140	1,680	350	4,200
MISC. WIRING W/CONDUIT		LS		2,000		5,000		7,000
FIRE PROTECTION ALARM & LIGHTS		LS		3,500		1,500		5,000
HEATING A/C & VENTILATION 50 TN., CONTROLS & RESISTOR COILS WITH INSULATED DIFFUSERS & GRILLES		LS		38,400		19,200		57,600

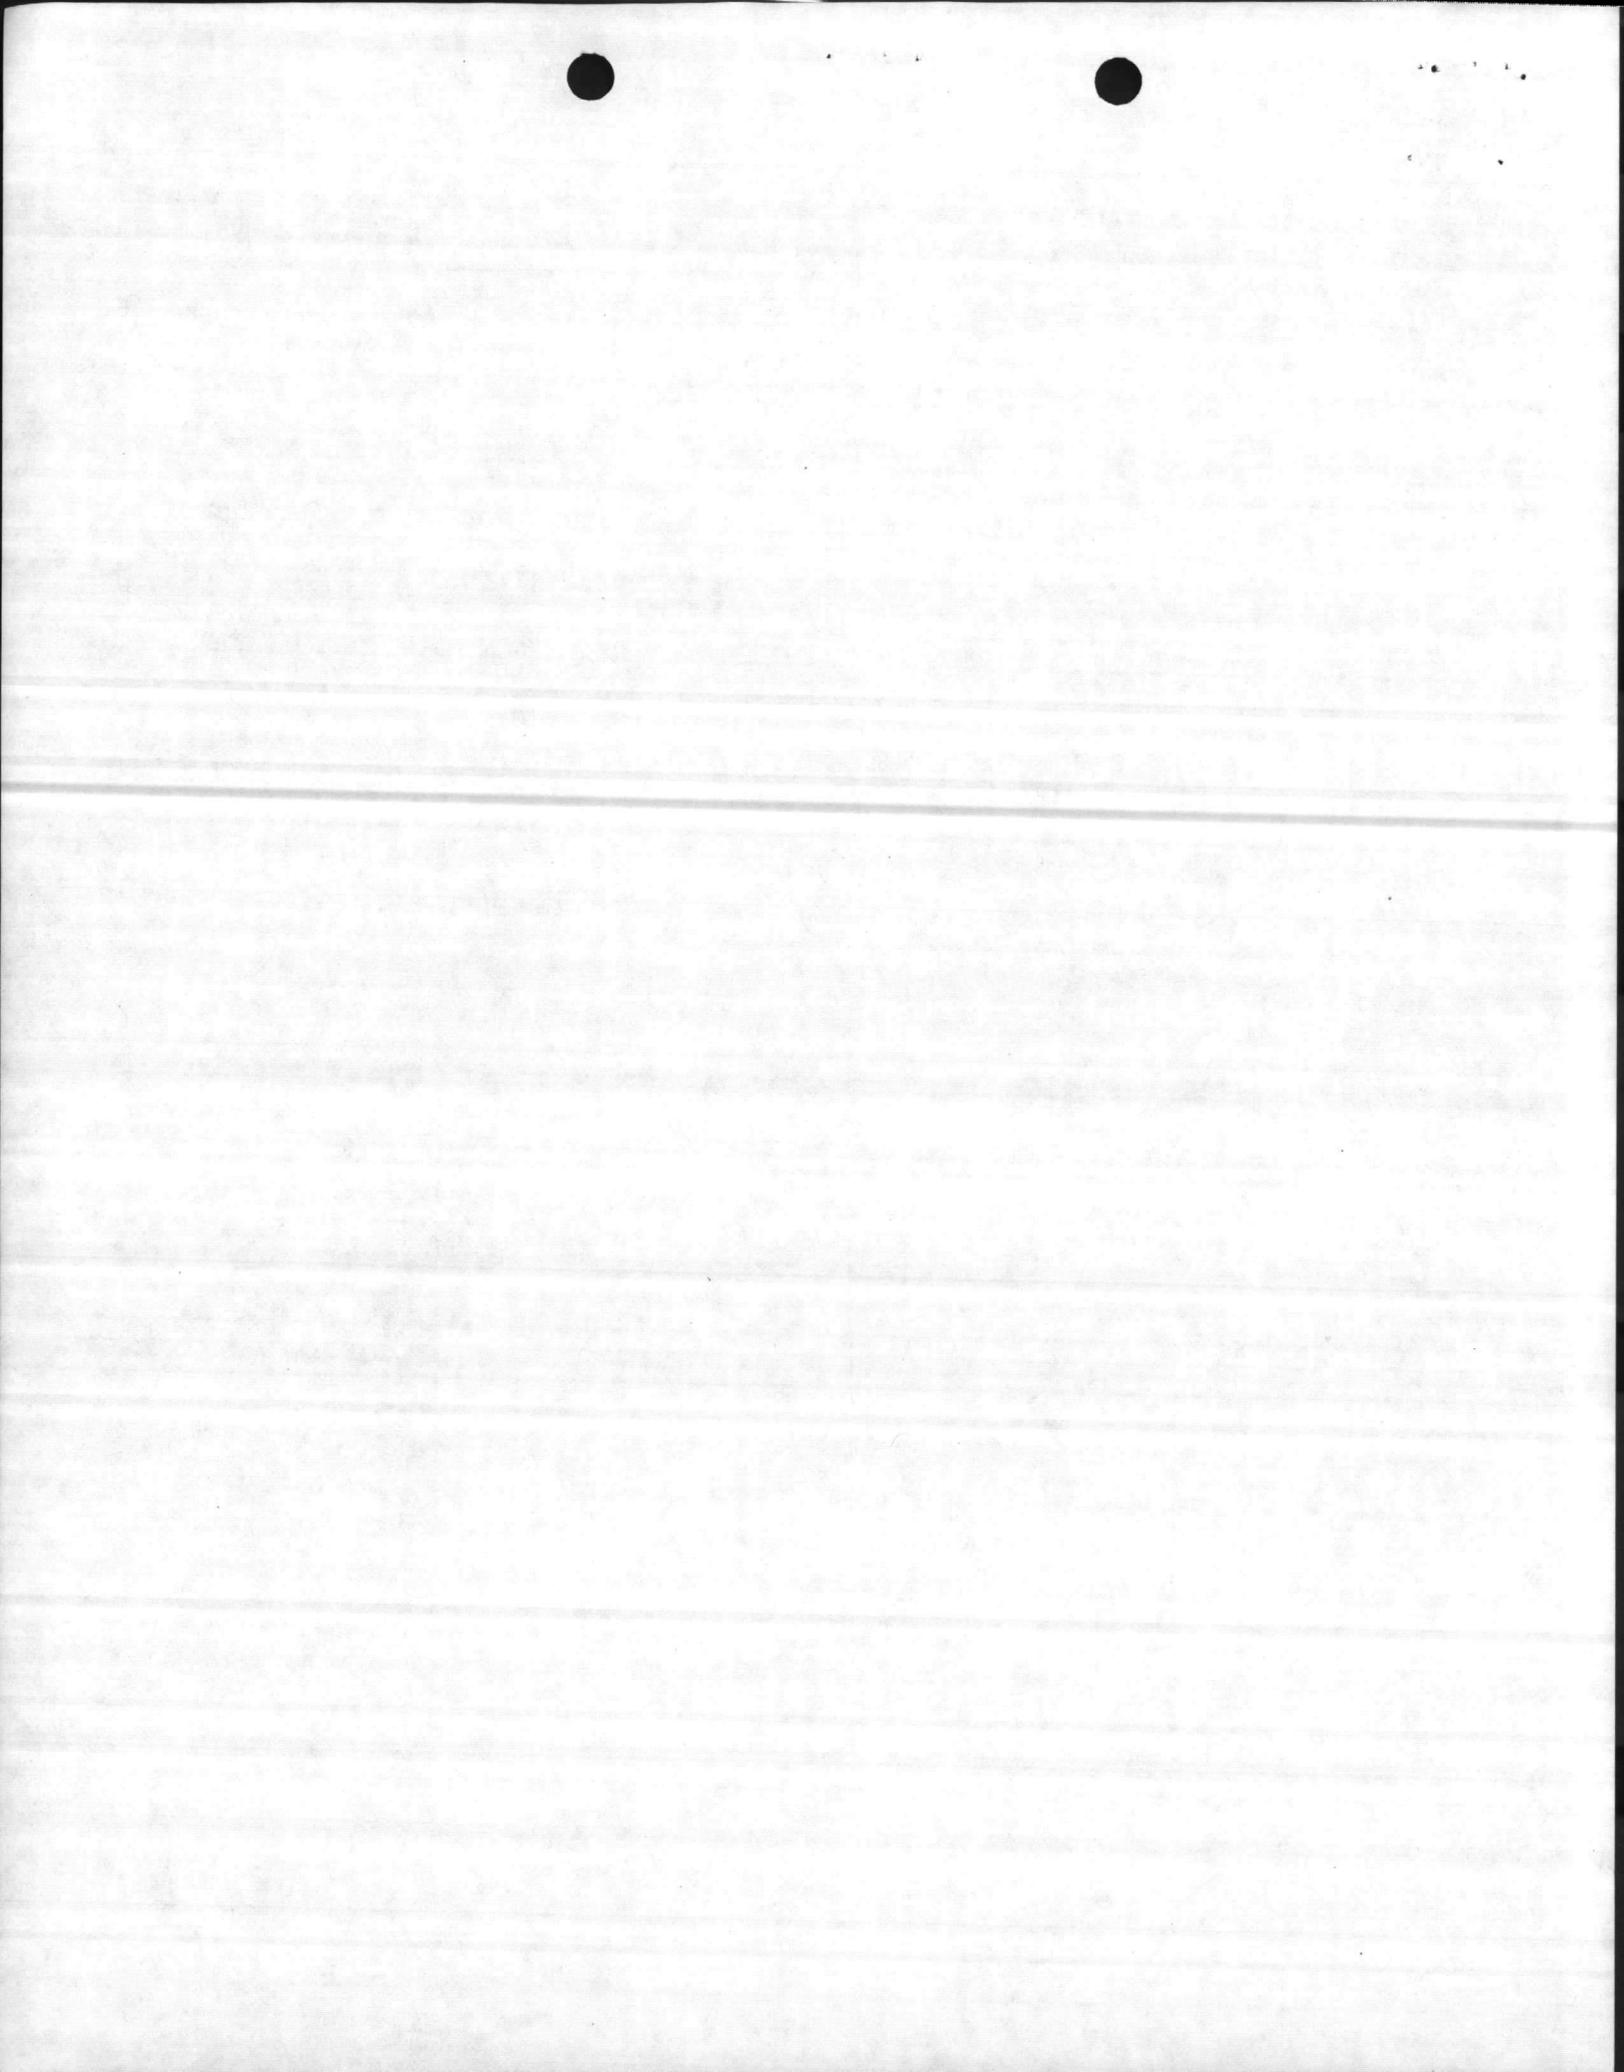

IDENTIFICATION NUMBER P-178
CATEGORY CODE NUMBER 740-02

AREA OR NO 5th ND	ACTIVITY MARINE CORPS BASE	LOCATION CAMP LEJEUNE, N.C.
----------------------	-------------------------------	--------------------------------

PROJECT (Or line item) TITLE

Location Exchange Area 1 & 2


ITEM (OR FEATURE) DESCRIPTION (Abbreviate if necessary)	QUANTITIES		MATERIAL COSTS		LABOR COSTS		ENGINEERING ESTIMATE	
	NO. OF UNITS	UNIT	UNIT COST	COST	UNIT COST	COST	UNIT COST	COST
1	2	3	4	5	6	7	8	9
EXHAUST FANS INCL HOOD EXHAUST PLUMBING	6	EA	250	1,500	60	360	310	1,860
TOILET FIXTURES W/PIPING	5	EA	225	1,125	225	1,125	450	2,250
FLOOR DRAINS W/PIPING	12	EA	170	2,040	115	1,380	285	3,420
ELEC DRINKING FTN.	3	EA	350	1,050	120	360	470	1,410
HOT WATER HEATER STM. 1000 gal.	1	EA		2,500		280		2,780
4" REINF. CONC. SLAB FTG. STOOPS ETC.		LS		8,000		2,500		10,500
ELECTRICAL TRANSFORMER 50KVA	6	EA	1,350	8,100	350	2,100	1,700	10,200
PAVING, GRADING & EXCAVATION				10,000		10,000		20,000
UTILITIES TO SITE LOCATION						5,000		5,000
EXHAUST HOOD & FANS FOR SODA FOUNTAIN				3,600				3,600
CEILING INSULATION	14,400	SF	.30	4,320	.10	1,440	40	5,760
				195,152		131,099		326,251
OVERHEAD 15%				29,273		19,665		48,938
INS., TAXES ON LABOR 12%								18,092
PROFIT 10%								393,281
BOND 1%								39,328
CONTINGENCY 10%								432,609
SIOH 5.5%								4,326
								436,935
								43,694
								480,629
								26,435
								507,064

PREPARED BY (Name)
C. W. Barnes
C. W. BARNES


APPROVED BY
C. J. Powell
C. J. POWELL

TITLE OR ORGANIZATION
PUBLIC WORKS DEPT.


DATE
21 MAR 1977

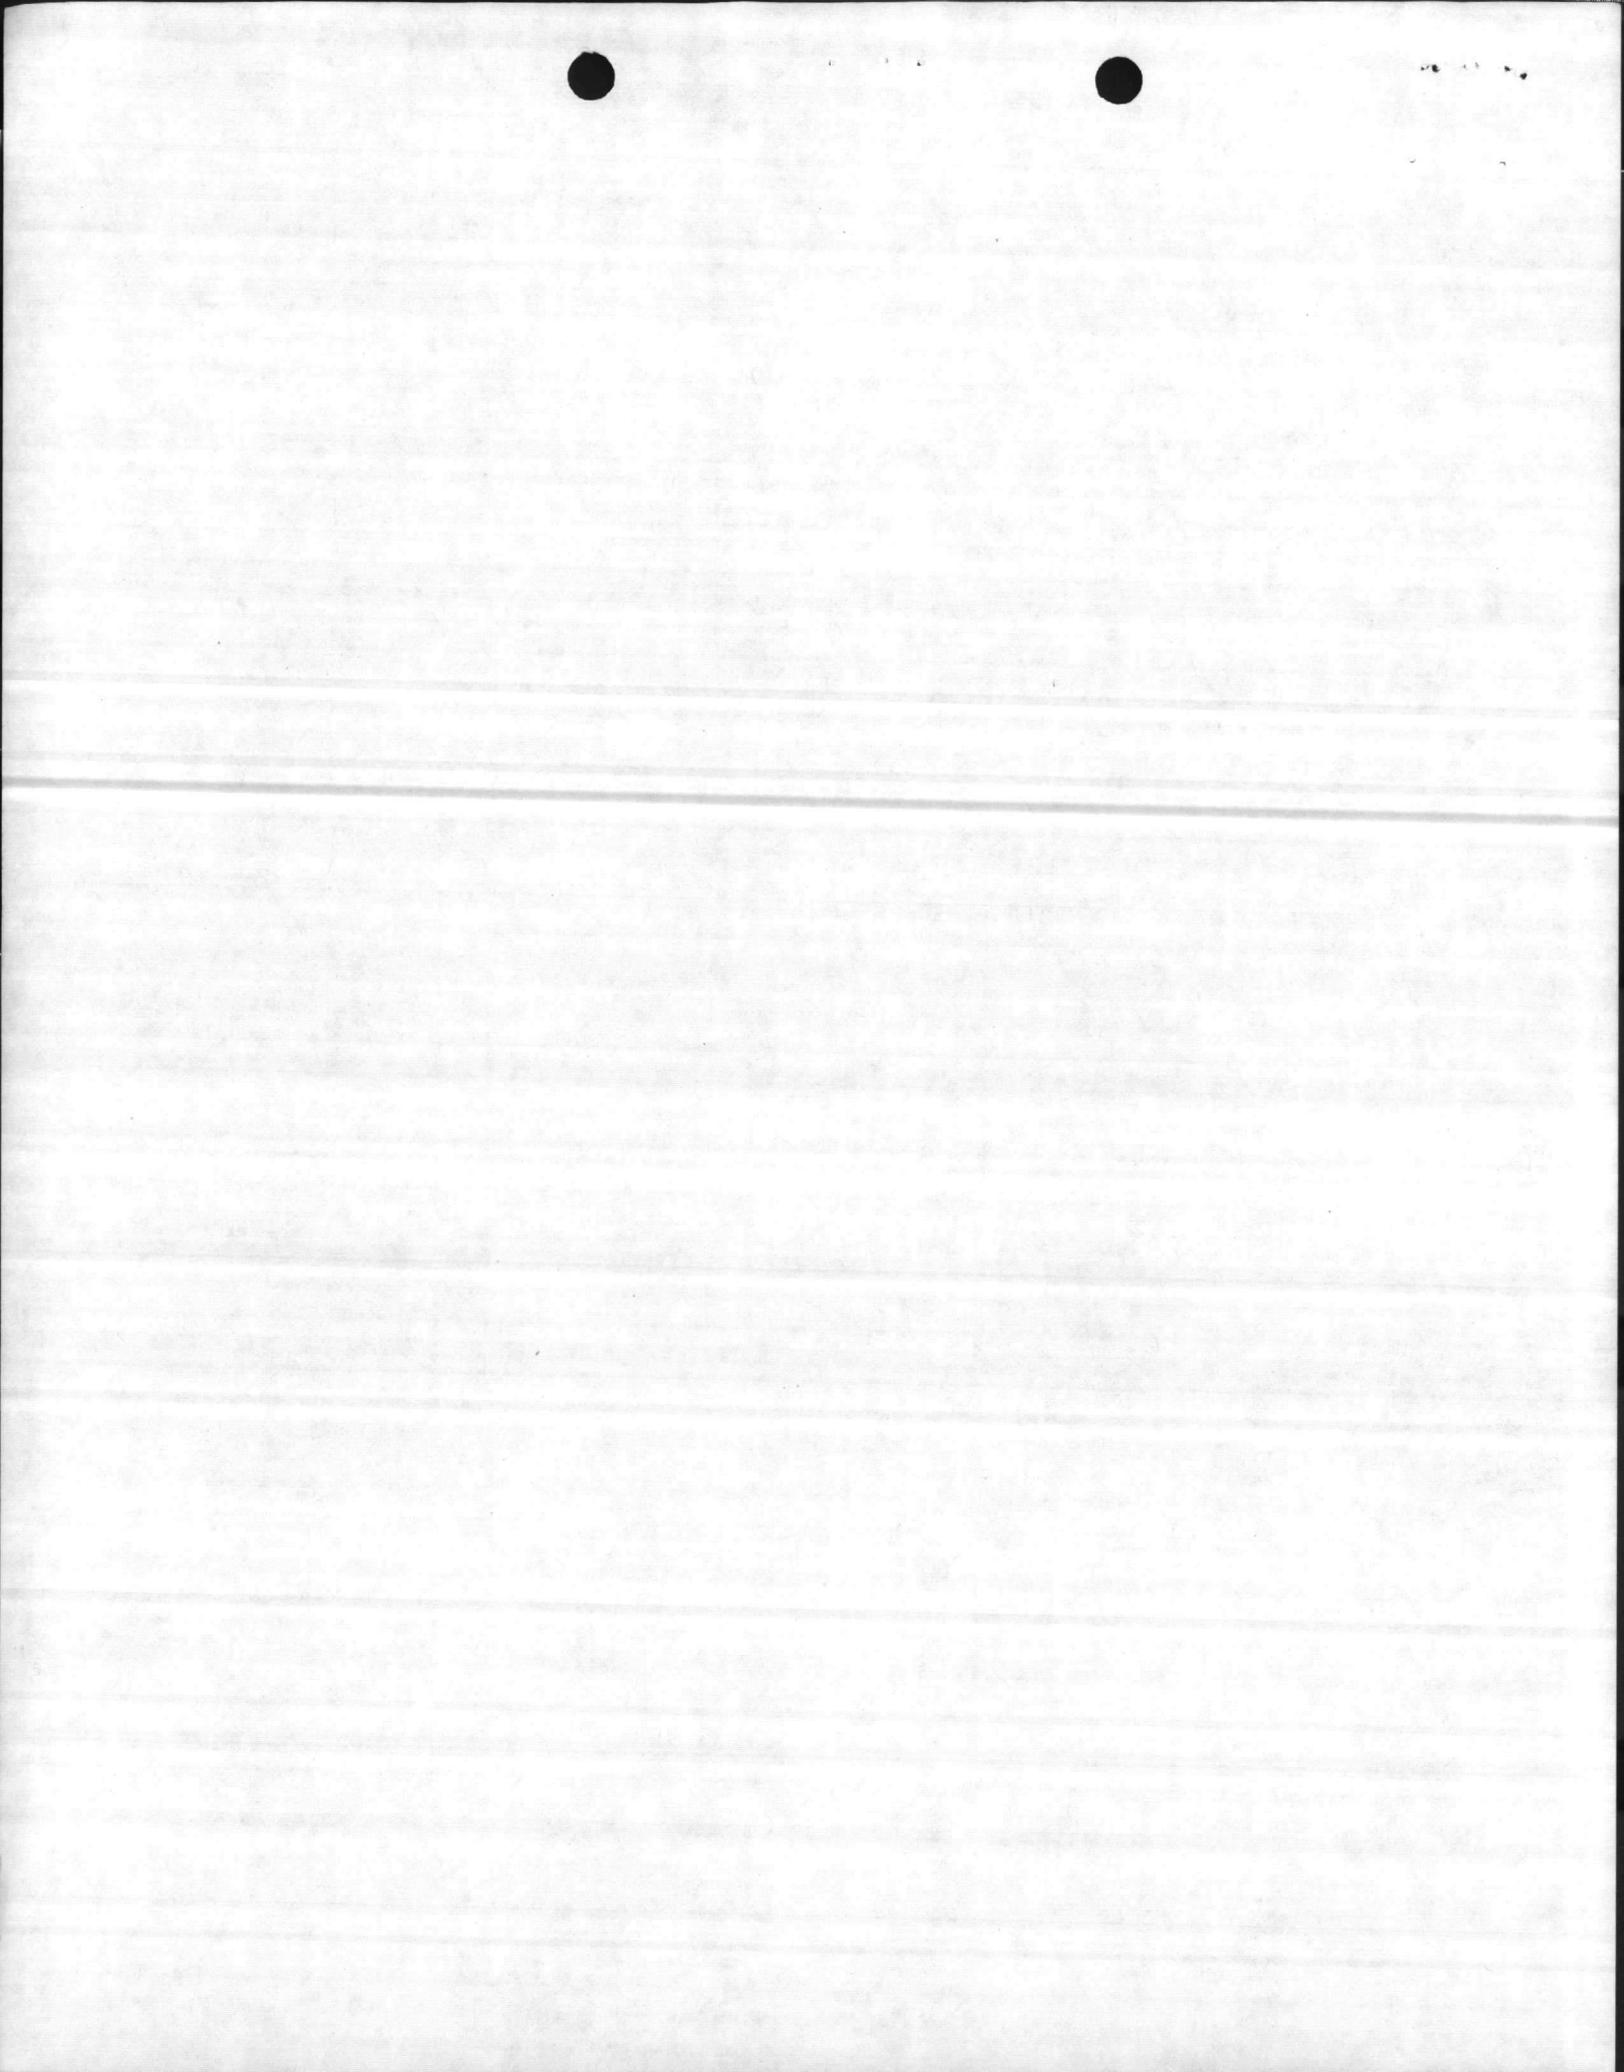


1. DATE 17 MAR 1977		2. FISCAL YEAR 1978		MILITARY CONSTRUCTION PROJECT DATA NONAPPROPRIATED FUNDS			3. DEPARTMENT NAVY		4. INSTALLATION MARINE CORPS BASE, CAMP LEJEUNE				
5. PROPOSED AUTHORIZATION \$ 507,000			6. PRIOR AUTHORIZATION P.L. -		7. CATEGORY CODE NUMBER 740-02		8. PROGRAM ELEMENT NUMBER		9. STATE/COUNTRY NORTH CAROLINA				
10. PROPOSED APPROPRIATION \$ 507,000				11. BUDGET ACCOUNT NUMBER			12. PROJECT NUMBER P-178		13. PROJECT TITLE HADNOT POINT AREA LOCATION EXCHANGE - AREAS 1 & 2		NM	CM	RM
SECTION A - DESCRIPTION OF PROJECT								SECTION B - COST ESTIMATES					
14. TYPE OF CONSTRUCTION		18. PHYSICAL CHARACTERISTICS OF PRIMARY FACILITY						20. PRIMARY FACILITY		U/M	QUANTITY	UNIT COST	COST (\$200)
a. PERMANENT	<input checked="" type="checkbox"/>	a. NO. OF BLDGS	b. NO. OF STORIES	c. LENGTH IRREG	d. WIDTH IRREG	e. GROSS AREA		LOCATION EXCHANGE	SF	14,400	\$31.77	\$ 457.5	
b. SEMI-PERMANENT		e. DESIGN CAPACITY	f. COOLING		CAP. COST		a.						
c. TEMPORARY		AIR COND		60 TN		\$ 50,000		b.					
15. TYPE OF WORK		19. DESCRIPTION OF WORK TO BE DONE						21. SUPPORTING FACILITIES					\$ 49.5
a. NEW FACILITY	<input checked="" type="checkbox"/>	Construct a Location Exchange at a central location between Areas 1 and 2. Construction to be of brick veneer on masonry walls, concrete floor, built-up roof over insulation. Air conditioning and heat pump system. Building to include retail exchange, snack bar, dry cleaning pickup station, and barber shop facilities. Construct parking lot. Utilities connected.						a. UTILITIES					(23.0)
b. ADDITION								b. FIRE ALARM SYSTEM					(2.5)
c. ALTERATION								c. PARKING					(19.0)
d. CONVERSION								d. SITE IMPROVEMENTS					(5.0)
e. OTHER (Specify)								e.					()
16. REPLACEMENT	<input checked="" type="checkbox"/>							f.					()
17. TYPE OF DESIGN								g.					()
a. STANDARD DESIGN	<input checked="" type="checkbox"/>							h.					()
b. SPECIAL DESIGN								i.					()
c. DRAWING NO.								j.					()
								22. TOTAL PROJECT COST					\$ 507.0
SECTION C - BASIS OF REQUIREMENT													
23. QUANTITATIVE DATA (U/M SQUARE FEET)						25. REQUIREMENT FOR PROJECT							
a. TOTAL REQUIREMENT HADNOT POINT BFRL 64,890						MISSION AND PROJECT. Provide housing, training facilities, logistical support, and certain administrative support for tenant Fleet Marine Force units and other units assigned. This project will enlarge and provide additional facilities for patrons in the 1st and 2nd Areas of the 2d Marine Division.							
b. EXISTING SUBSTANDARD (6,765)						REQUIREMENT. Troops of the 2d Marine Division are located in the area of proposed construction. A larger Exchange, Snack Bar, Dry Cleaning Pickup Station, and Barber Shop will improve service to patrons.							
c. EXISTING ADEQUATE 39,960						CURRENT SITUATION. Minimum exchange functions are going on in a wing of enlisted service clubs in Areas 1 and 2.							
d. FUNDED, NOT IN INVENTORY -						IMPACT IF NOT PROVIDED. Inadequate exchange facilities for exchange patrons in these areas.							
e. ADEQUATE ASSETS (c + d) 39,960													
						AUTHORIZED		FUNDED					
f. UNFUNDED PRIOR AUTHORIZATION -						-		-					
g. INCLUDED IN FY - PROGRAM -						-		-					
h. DEFICIENCY (a - e - f - g) 24,930						-		-					
24. RELATED PROJECTS -													

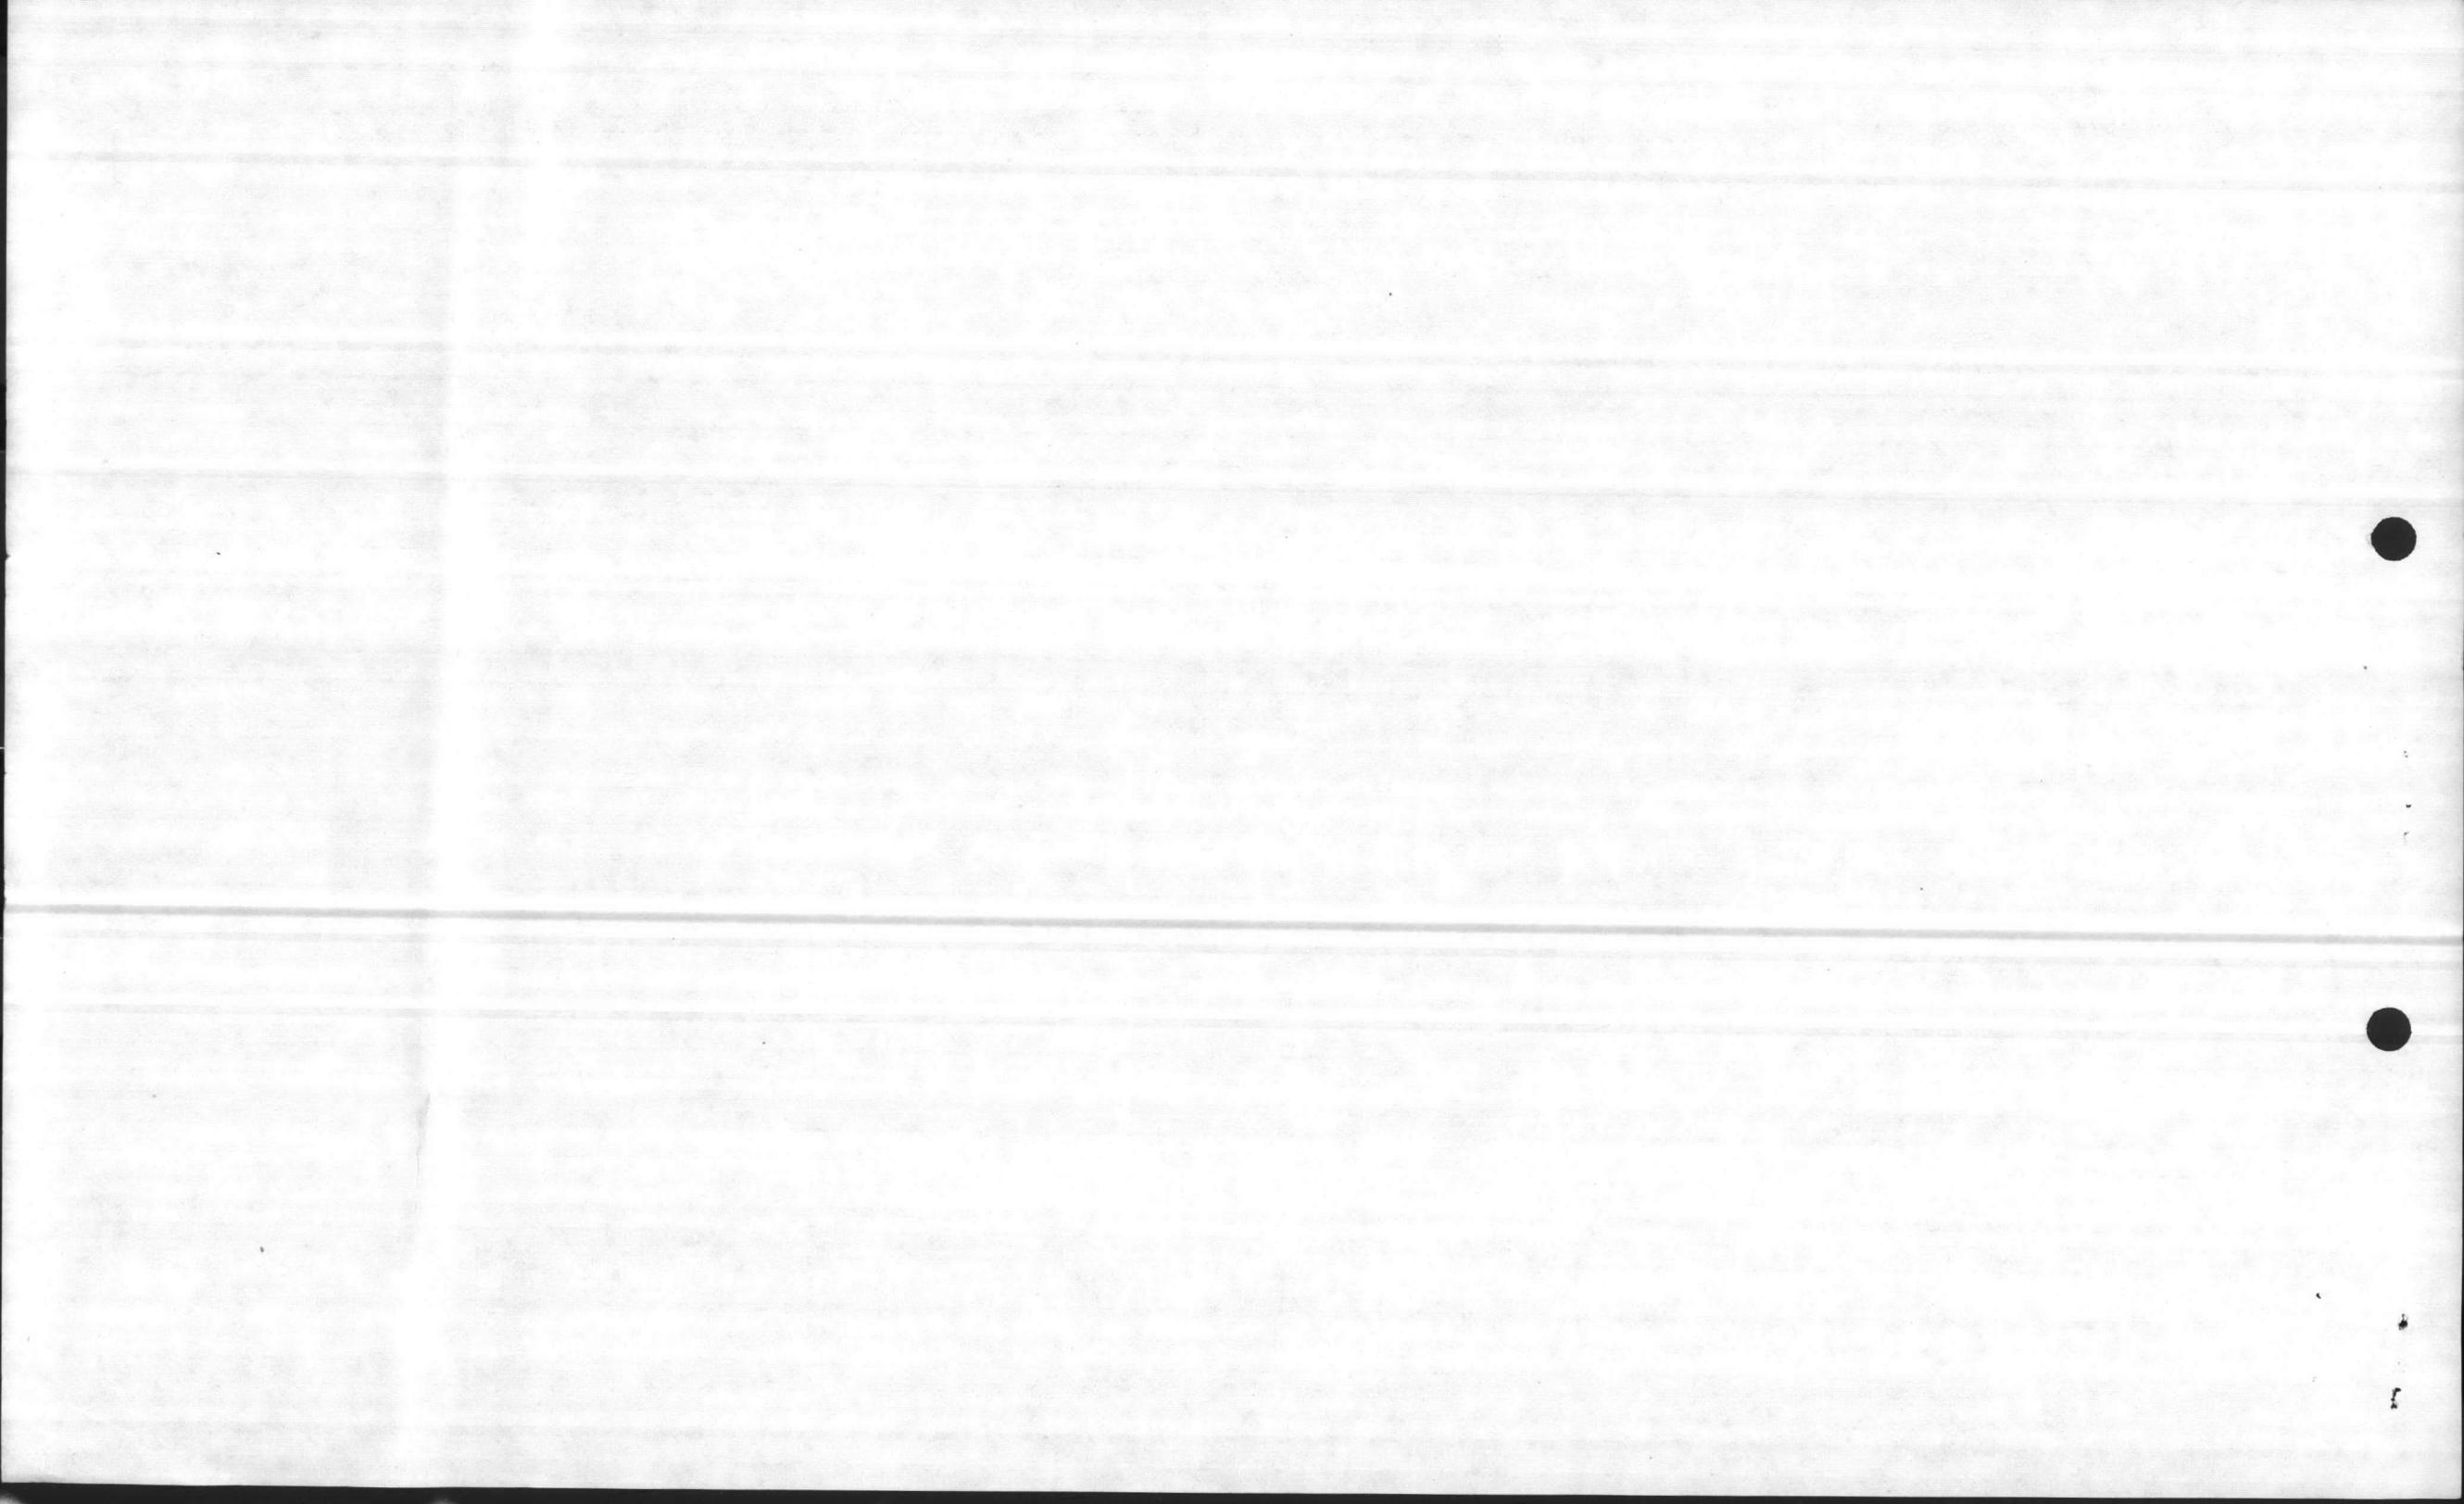

1. DATE 17 MAR 1977	2. FISCAL YEAR 1978	MILITARY CONSTRUCTION PROJECT DATA (Continued)	3. DEPARTMENT NAVY	4. INSTALLATION MARINE CORPS BASE, CAMP LEJEUNE, NORTH CAROLINA
5. PROJECT NUMBER P-178		6. PROJECT TITLE HADNOT POINT AREA LOCATION EXCHANGE - AREAS 1 & 2		
<p><u>SPECIAL CONSIDERATIONS</u></p> <ol style="list-style-type: none"> 1. <u>POLLUTION PREVENTION, ABATEMENT, AND CONTROL.</u> This project will not cause additional air or water pollution. 2. <u>FLOOD HAZARD EVALUATION.</u> Requirements of Executive Order No. 11296 (flood hazards) are not applicable. 3. <u>ENVIRONMENTAL IMPACT.</u> An environmental impact assessment has been made, and it has been determined that the proposed project will have neither a significant impact on the environment nor is it highly controversial. 4. <u>USE OF AIR CONDITIONING.</u> Ceiling "U" factors will be made to conform with DoD 427C.1-M. 				

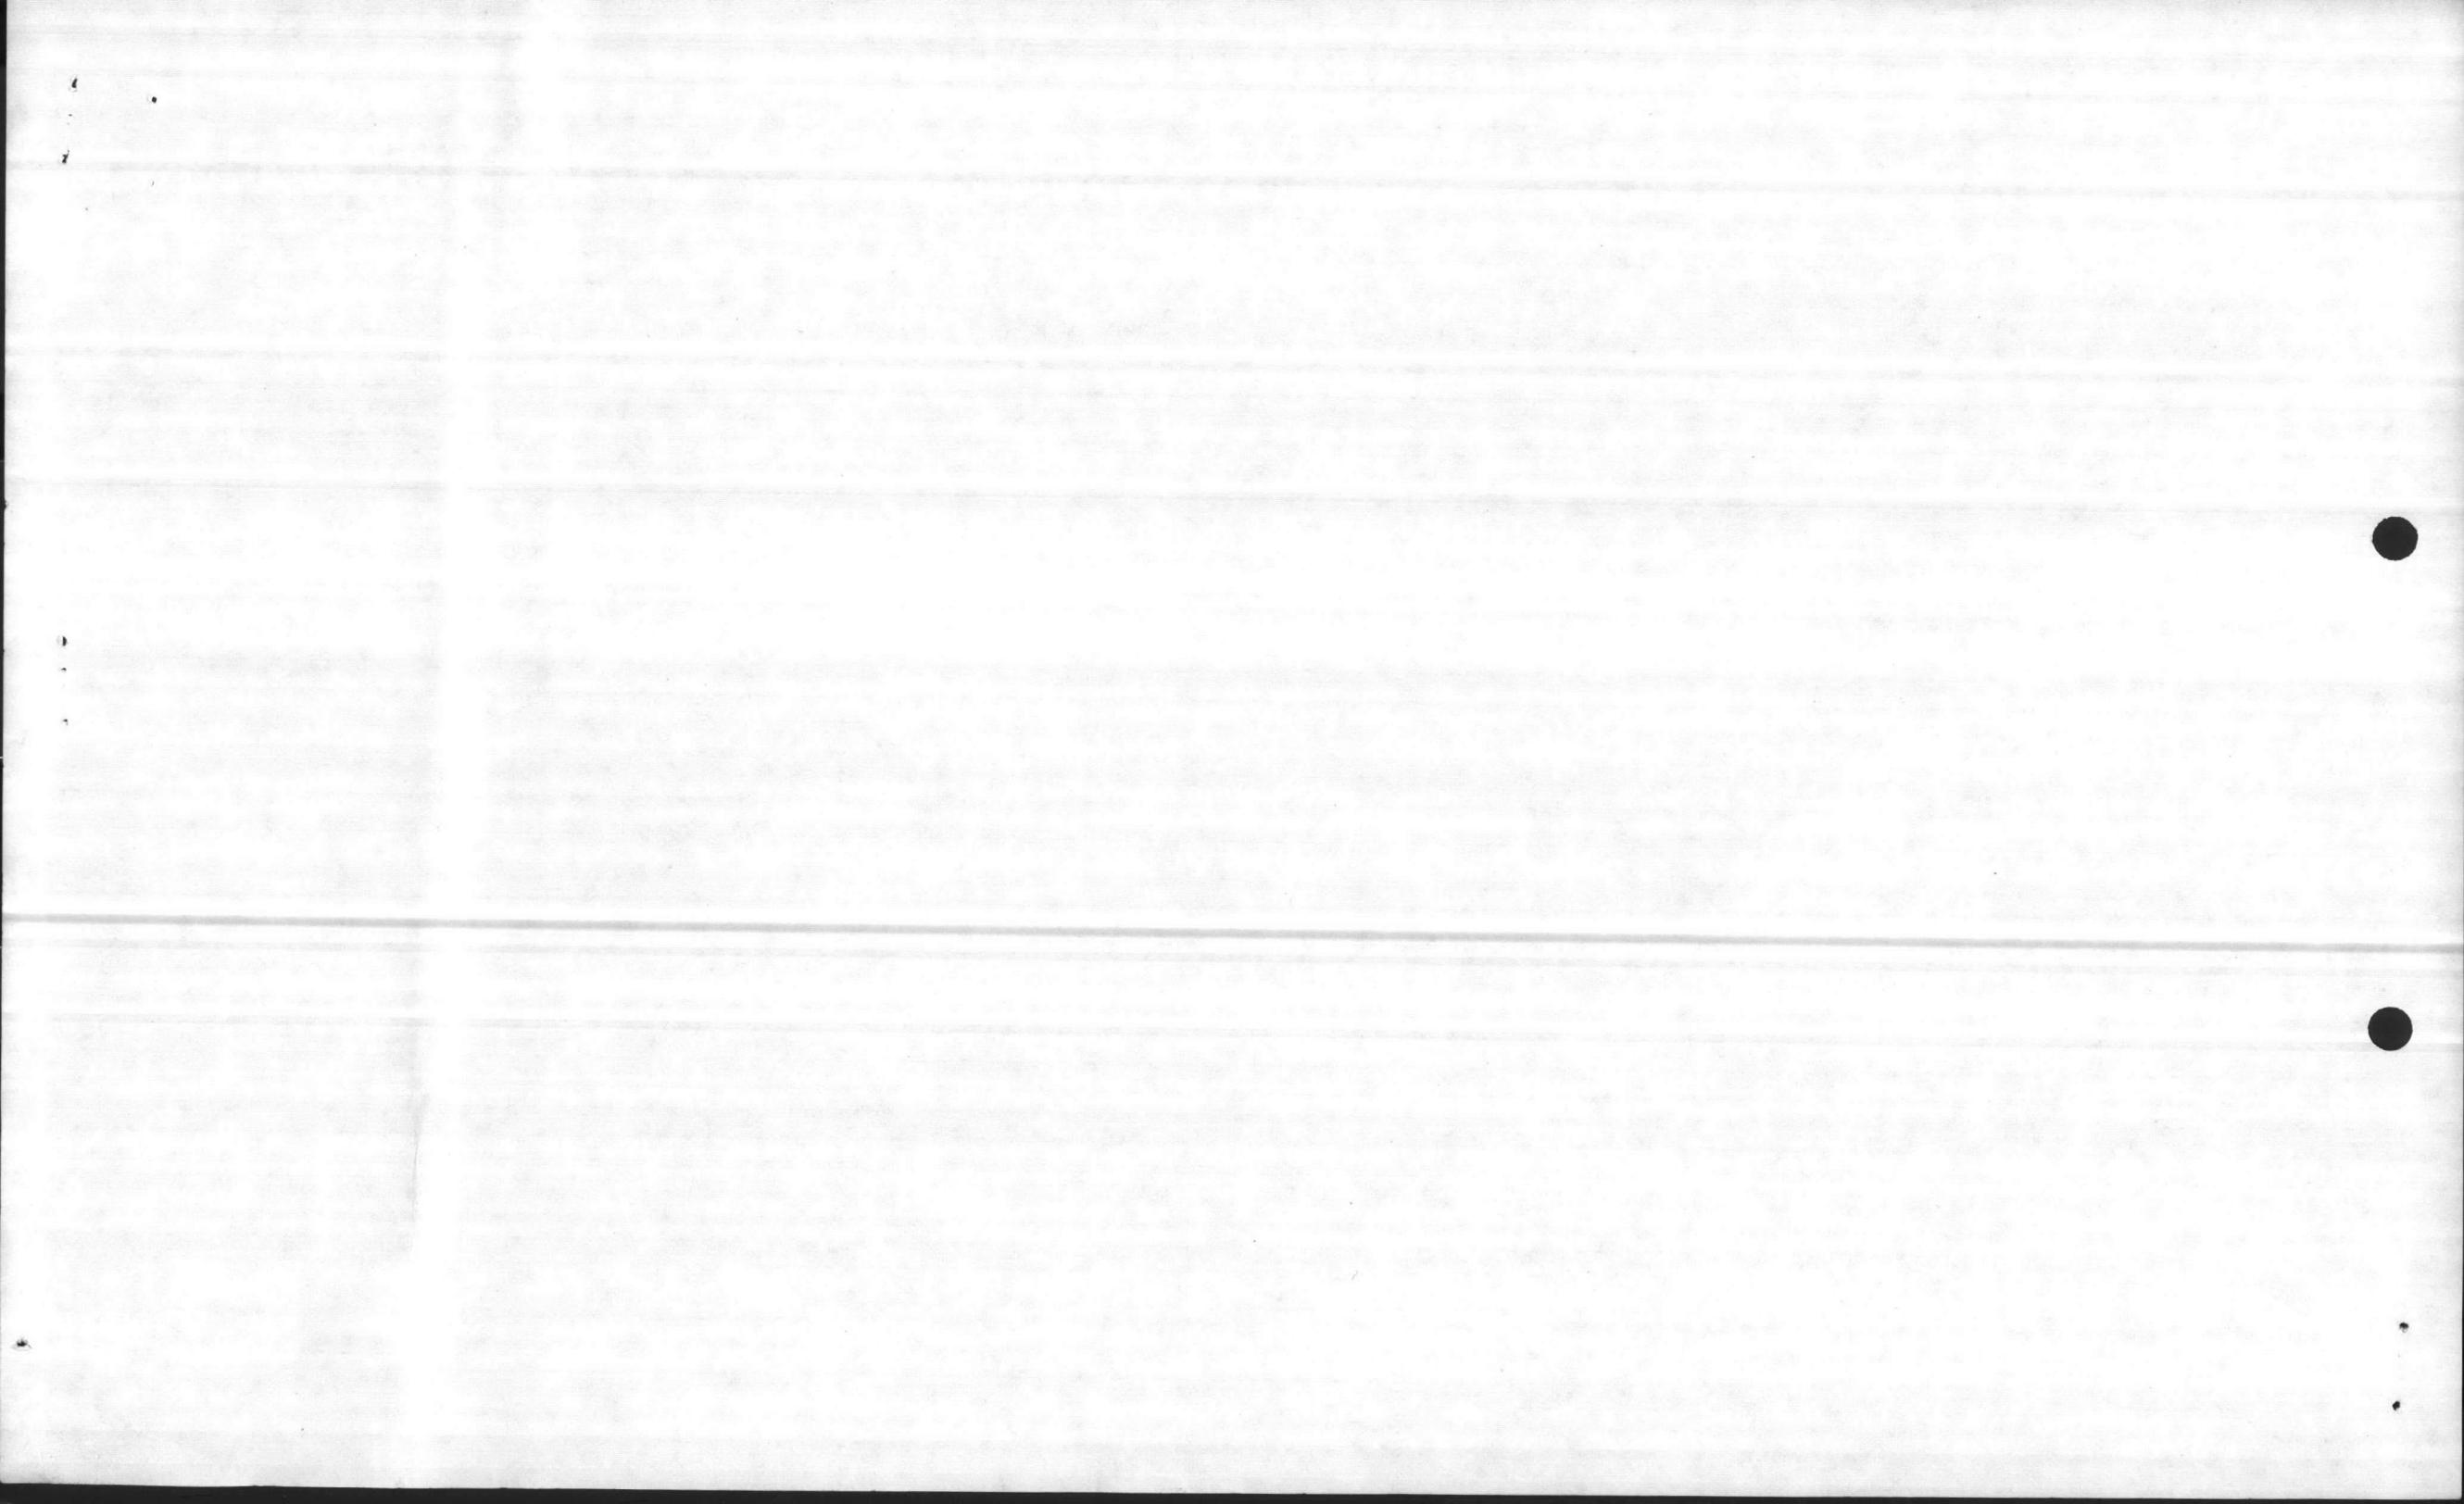

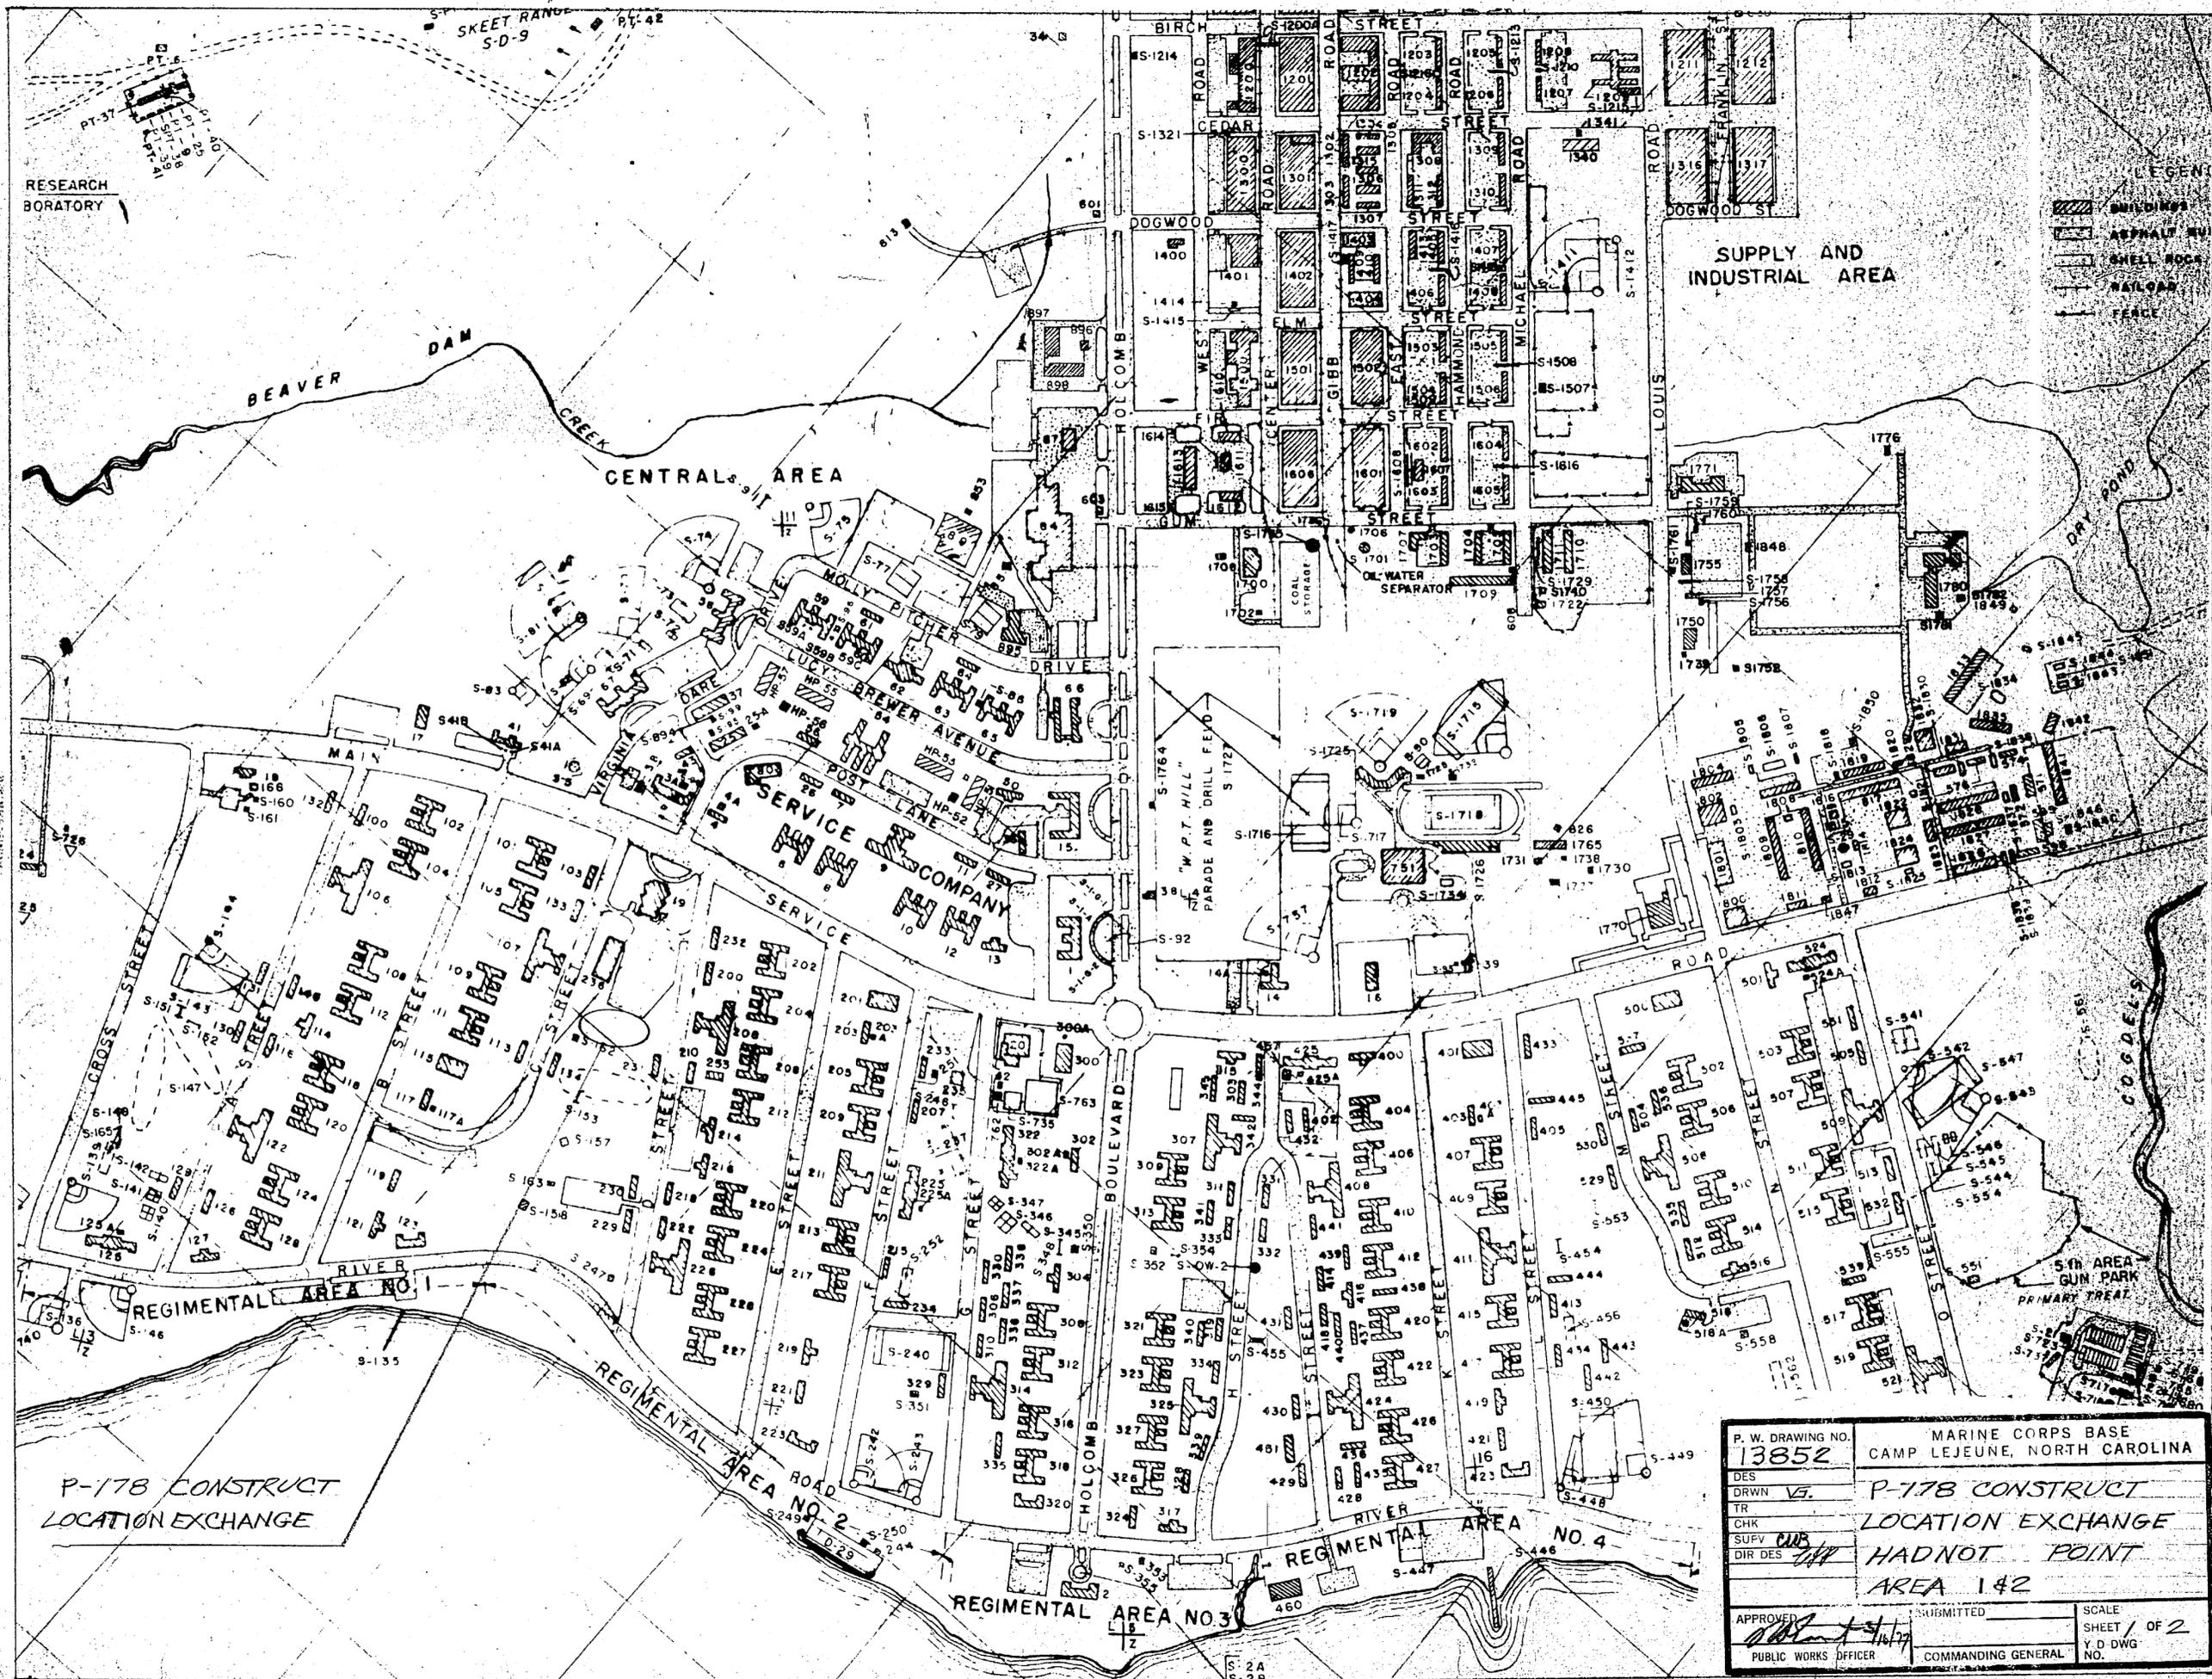

RESEARCH
BORATORY

BEAVER DAM

CENTRAL AREA

SUPPLY AND
INDUSTRIAL AREA

- LEGEND
- BUILDING
 - ASPHALT
 - SHELL ROCK
 - RAILROAD
 - FENCE

P-178 CONSTRUCT
LOCATION EXCHANGE

REGIMENTAL AREA NO. 1

REGIMENTAL AREA NO. 2


REGIMENTAL AREA NO. 3

REGIMENTAL AREA NO. 4


5th AREA
GUN PARK
PRIMARY TREAT

P. W. DRAWING NO. 13852		MARINE CORPS BASE CAMP LEJEUNE, NORTH CAROLINA	
DES	DRWN <i>VS</i>	P-178 CONSTRUCT	
TR	CHK	LOCATION EXCHANGE	
SUFV	DIR DES	HADNOT POINT	
		AREA 142	
APPROVED <i>[Signature]</i>	SUBMITTED	SCALE	SHEET 1 OF 2
PUBLIC WORKS OFFICER	COMMANDING GENERAL	Y. D. DWG.	NO.


[The page contains extremely faint and illegible text, likely bleed-through from the reverse side of the document. The text is arranged in several columns and is mostly illegible due to low contrast and blurriness.]

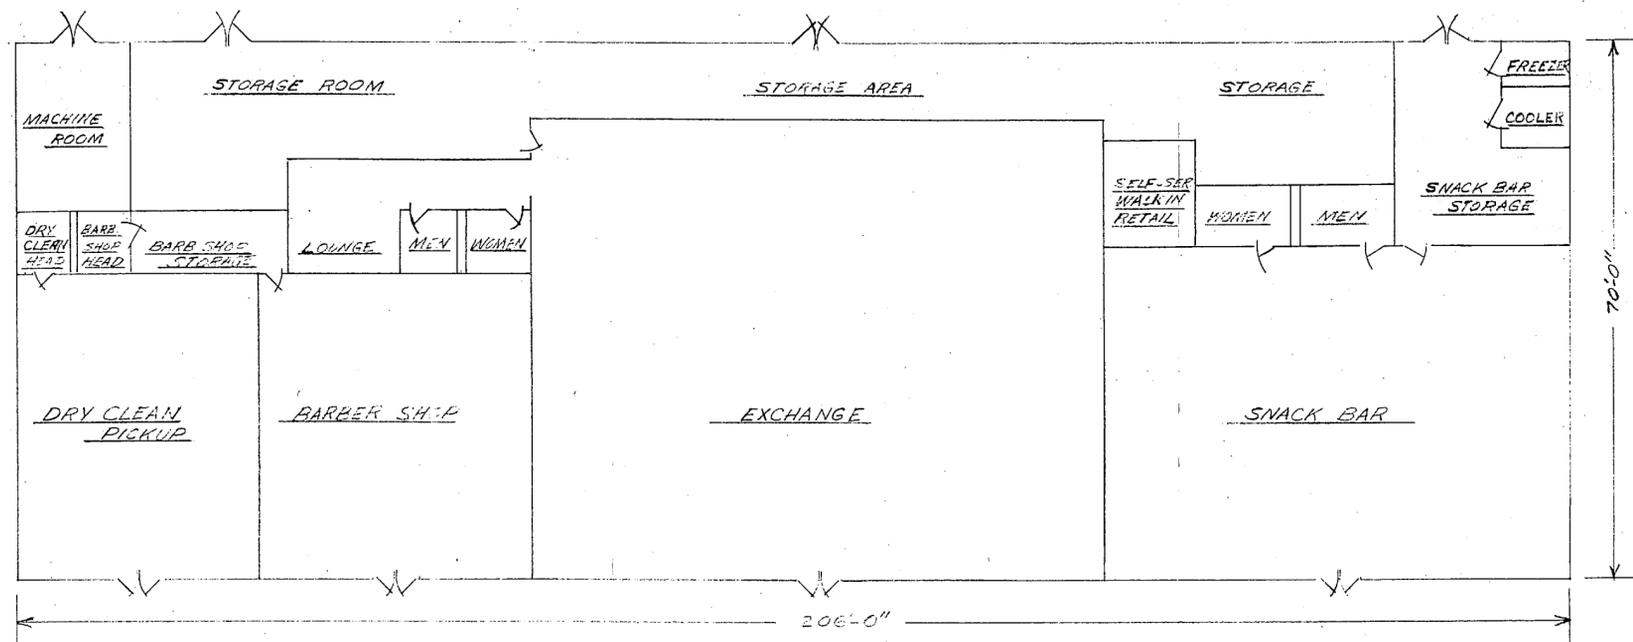


FLOOR PLAN
SCALE 1/8" = 1'-0"

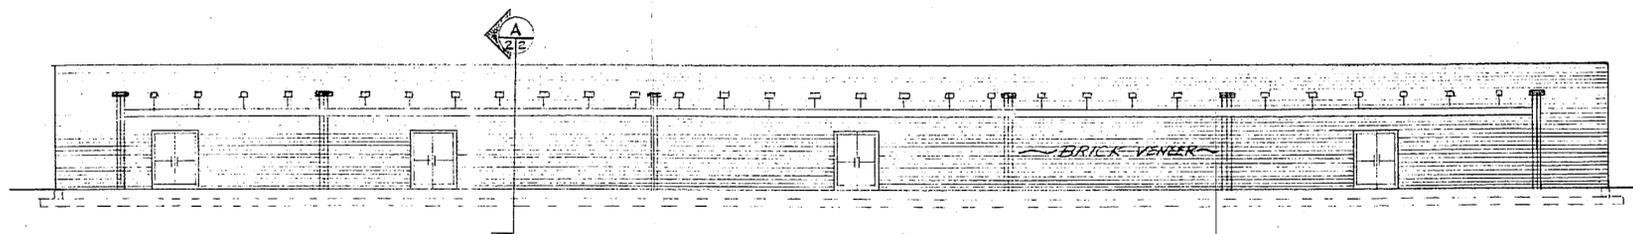

FRONT ELEVATION
SCALE 1/8" = 1'-0"

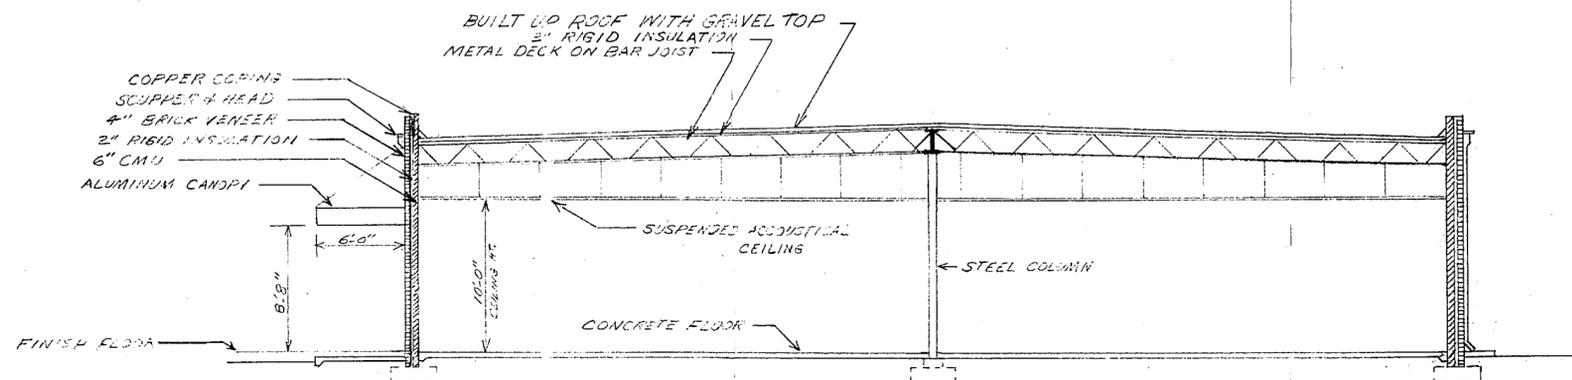

SECTION A-A
SCALE 1/8" = 1'-0"

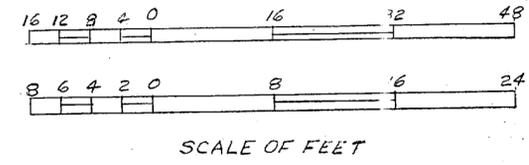

P. W. DRAWING NO. 13853		MARINE CORPS BASE CAMP LEJEUNE, NORTH CAROLINA	
DES DRWN DDW		P-173	
CHK SHPY <i>MB</i>		CONSTRUCT LOCATION EXCHANGE HADNOT POINT (142)	
DIR DES <i>MB</i>		PLAN, ELEVATION & SECTION	
APPROVED <i>MB</i> PUBLIC WORKS OFFICER	SUBMITTED 3/28/77	SCALE GRAPHIC SHEET 2 OF 2 Y D DWG NO.	COMMANDING GENERAL

The first part of the document discusses the importance of maintaining accurate records of all transactions. It emphasizes that every entry should be supported by a valid receipt or invoice. This ensures transparency and allows for easy auditing of the accounts.

In the second section, the author details the various methods used to collect and analyze data. This includes both primary and secondary research techniques. The primary research involved direct observation and interviews with key stakeholders, while secondary research focused on reviewing existing literature and industry reports.

The third section presents the findings of the study. It highlights several key trends and patterns observed in the data. For example, there was a significant increase in the use of digital services over the past few years, which has led to a shift in consumer behavior. Additionally, the study found that customer loyalty programs are becoming increasingly important for businesses looking to retain their market share.

Finally, the document concludes with a series of recommendations for future research and practical applications. It suggests that further studies should be conducted to explore the long-term effects of digitalization on the economy. On a practical level, businesses are advised to invest in digital marketing strategies and to regularly update their customer relationship management systems to stay competitive in a rapidly changing market.

FIG:04:YEA:sh
60-0159

24 JUN 1980

20
04

McKimmon/Edwards/Hitch Architects
420 North Boylan Avenue
Raleigh, N. C. 27603

Re: Contract #62470-80-R-3753, Location Exchanges, Radnot Point
(Areas 1 & 2 and 4 & 5) (N-104 and N-105), MCB Camp Lejeune,
N. C.

Gentlemen:

Reference is made to your letter of 16 May 1980 concerning the pre-design conference held on 13 May 1980. The minutes of the meeting have been reviewed and are satisfactory to this Command.

In response to specific questions raised in your letter, the following comments are provided:

(1) The steam tunnel should not be covered with soil. In the past we have been unable to adequately establish vegetation over steam tunnels covered with soil.

(2) The desired interface mechanism for the HVAC system is a design feature elaborated on in the publication, "Architects and Engineers Guide for Interfacing into Energy Monitoring and Control Systems", which can be obtained from the Atlantic Division, Naval Facilities Engineering Command, Norfolk, Virginia 23511. Contacts are Mr. Charlie Rose or Mr. Hal Motter in the Specifications Branch, LANTDIV Design Division, telephone (804) 444-3474. The enclosed type specifications also may be of assistance in this matter.

The preliminary site plans that you forwarded have been reviewed and are considered to be satisfactory. One copy of each plan is returned herewith.

Should you have additional questions, please contact Mr. Larry Stallings, Architectural Branch, Public Works Department, telephone (919) 451-3658.

Sincerely,

V. PODSINKSKI
CDR, USN
Public Works Officer
By direction of the Commanding General


Enclosures

Copy to:
COMLANTNAVFACENGCOM
CNC (LFF-2)

Blind copy to:
MCX
AC/S, Fac

Return to 04

1001 VOL 1

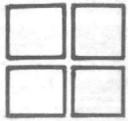

mckimmon \ edwards \ hitch architects

arthur mckimmon ii, aia

james m. edwards iii, aia

john l. hitch, aia

May 16, 1980

Mr. Larry Stallings
Public Works Engineering
Marine Corps Base
Camp Lejeune, N. C. 28542

Re: Contract N62470-80-B-3753, N-104 (Areas 1 and 2) and N-105
(Areas 4 and 5) Location Exchanges, Hadnot Point, Marine
Corps Base, Camp Lejeune, North Carolina

Dear Larry:

On Tuesday, May 13, 1980, a pre-design conference was held with Larry Stallings of Public Works, James Waugh of Marine Corps Exchange, Shelton Adcock and John Hitch of McKimmon/Edwards/Hitch, Architects present. The following is a summary of salient points of discussion from the conference.

1. Refuse disposal and borrow area are located 5 miles from Area 1 and 2, and 4 miles from Area 4 and 5.
2. Areas around buildings will be grassed under this contract. Landscaping, if desired at a later date, will be accomplished by others.
3. Economizer cycle for Summer non-airconditioning periods.
4. Any duct work exposed to the exterior which is large enough for human passage shall have a security grille installed at the point of entrance to the building.
5. Base prefers roof to be designed around Factory Mutual design requirements rather than LANTDIV standard specification. Since this project is a site adaptation (except HVAC), changing roofing specifications is beyond the scope of the A & E contract. (If the Base wishes to provide such a specification for our use, we will incorporate it at no change in fee.)
6. At the request of the Marine Corps Exchange, plans for Public Works, NAF Washington and Marine Corps Exchange are to be sent by bus to Jim Waugh to make further distribution.
7. Survey crew to notify Jim Waugh upon arrival on base.
8. Locks to be Best Locking System and Government to furnish final cores.

9. Revised Progress Schedule:

- | | |
|--|------------------|
| (a) Received verbal authority to proceed | 9 May 1980 |
| (b) Pre-design Conference | 13 May 1980 |
| (c) 35% Submittal | 1 July 1980 |
| (d) 90% Submittal | 1 September 1980 |
| (e) 100% Submittal | 1 November 1980 |

It was noted that the above schedule is based on a 35 day review period for each submittal. The schedule for 90% and 100% submittals may be improved particularly if government review period is held to 35 days or less.

10. Area 1 and 2 Exchange:

- (a) Scheme "C" was selected as the most suitable site plan. The 50-space parking area has access only from "D" Street and does not connect with existing parking at Building 236. Pedestrian traffic connections are made to both "C" and "D" Streets. In order to avoid asphalt removal in Building 236 parking lot, the parking area for Scheme "C" is to be modified as required, but the new scheme is to maintain the essence of Scheme "C". (Scheme "C" has been modified and is enclosed herewith.)
- ✓ (b) Base Public Works is to advise A & E whether part of steam tunnel may be covered with 5" to 10" of earth as indicated on the enclosed plan.

11. Area 4 and 5 Exchange:

- (a) Scheme "B" was selected as most suitable with Scheme "A" as the base bid configuration. (Scheme "B" with provision for base bid and alternates is enclosed herewith.)
- (b) It was requested that an add alternate for providing a pedestrian connection to "L" Street be incorporated. The connection would involve approximately 300 feet of sidewalk and steps, and 50 feet of foot bridge (timber) to cross a ravine.
- (c) Building 530 slab and foundation to be removed by base forces.

Subsequent to the conference the following information was provided by or requested of Public Works Engineering:

- 1. The building sign will read "Marine Corps Exchange" rather than designation by specific area.
- ✓ 2. Public Works to advise A & E of desired interface mechanism for connection of HVAC to the EMCS system.
- 3. Plans for steam tunnel pits were provided for A & E's use.
- 4. Public Works Engineering requested that water to air heat pump be evaluated in "Trace" energy analysis along with air to air heat pump and steam.

5. Proposed utility connection points for fire alarm, water, sewer, electrical service and steam were approved. (Telephone connection point approved on prior visit by the telephone office.)
6. Monument N339,656,16, E 2,495,516.05, Elev 25.22 is acceptable to use as bench mark for Area 1 and 2, and monument N335,734,61, E 2,498,376.61, Elev 26.60 is acceptable as bench mark for Area 4 and 5.

Enclosed herewith are three copies of Area 1 and 2, and Area 4 and 5 "Preliminary Site Plans" for approval. Please indicate that the plans are satisfactory to Public Works Engineering by signing and returning one copy. Approval is for general utility layout, location, and parking arrangement only.

Sincerely,

McKIMMON/EDWARDS/HITCH, ARCHITECTS



John L. Hitch, AIA

JLH:md

Enclosures

cc: Mr. E. M. Glass
Mr. Jim Waugh
Mr. Charlie Pye
Mr. M. L. Bryant

Proposed utility connection points for fire alarm, water, sewer, electrical, service and steam water connection. (Reference to the utility service on site visit by the reference office.)

Minimum area for the lot is 10,000 sq. ft. It is acceptable to use as much as 10,000 sq. ft. and minimum area is 10,000 sq. ft.

Included herein are three copies of Area 1 and 2 and a preliminary site plan for removal. These include all the lines and structures to be removed. Engineering by standing and retaining for utility is for area 1 only. Location and utility structure only.

PROPOSED
REMOVAL
PLAN

DATE: 10/15/1988
BY: [Signature]
TITLE: [Title]



MARINE CORPS EXCHANGE 0131
MARINE CORPS BASE
CAMP LEJEUNE, NORTH CAROLINA 28542

IN REPLY REFER TO:
MCEX/JDW/wh
4700/7000 (Special)
23 May 1980

From: Marine Corps Exchange Officer
To: Public Works Officer, Marine Corps Base, Camp Lejeune, North Carolina 28542

Subj: Pre-Design Conference, Location Exchanges 1 & 2 (N104) and 4 & 5 (N105)

Ref: (a) McKimmon, Edwards and Hitch ltr of 16 May 1980
(b) FONECON between Mr. Charlie Pye, NAF Architect (Code LFF-1) and Mr. J. D. Waugh, MCX 0131 Property & Maintenance Director on 23 May 1980

1. Reference (a) detailed the minutes of the Pre-Design Conference for Location Exchanges 1 & 2 (N-104) and 4 & 5 (N-105) held on Tuesday, 13 May 1980. The Marine Corps Exchange, Camp Lejeune, North Carolina concurs with the minutes of this meeting.

2. By reference (b) Mr. Charlie Pye, Code LFF-1, Headquarters, U. S. Marine Corps concurred and will forward correspondence to that effect.

3. It is requested that Public Works prepare correspondence to McKimmon, Edwards and Hitch architects indicating site plans are satisfactory and advising them to proceed with 35% submittal.


E. M. GLASS

Copy to:
Mr. Charlie Pye, Code LFF-1,
HQMC,
Washington, DC 20380

Gilbert bond

1950

1. The first part of the document is a letter from the author to the editor of the journal. The letter is dated 1950 and is addressed to the editor of the journal. The author discusses the importance of the research and the results of the study. The author also mentions the need for further research in this area.

2. The second part of the document is a list of references. The references are listed in alphabetical order and include the following works:

- 1. Smith, J. (1948). The effect of temperature on the rate of reaction. *Journal of Chemical Physics*, 16, 592-598.
- 2. Jones, A. (1949). The kinetics of the reaction between hydrogen and oxygen. *Proceedings of the Royal Society (London)*, A200, 1-10.
- 3. Brown, C. (1950). The mechanism of the reaction between hydrogen and oxygen. *Journal of Chemical Physics*, 18, 100-105.

1950

MCEX/JDW/wh
4700/7000 (Special)
23 May 1980

From: Marine Corps Exchange Officer
To: Public Works Officer, Marine Corps Base, Camp Lejeune, North Carolina 28542

Subj: Pre-Design Conference, Location Exchanges 1 & 2 (N104) and 4 & 5 (N105)

Ref: (a) McKinmon, Edwards and Hitch ltr of 16 May 1980
(b) FONECON between Mr. Charlie Pye, NAF Architect (Code LFF-1) and Mr. J. D. Waugh, MCX 0131 Property & Maintenance Director on 23 May 1980

1. Reference (a) detailed the minutes of the Pre-Design Conference for Location Exchanges 1 & 2 (N-104) and 4 & 5 (N-105) held on Tuesday, 13 May 1980. The Marine Corps Exchange, Camp Lejeune, North Carolina concurs with the minutes of this meeting.
2. By reference (b) Mr. Charlie Pye, Code LFF-1, Headquarters, U. S. Marine Corps concurred and will forward correspondence to that effect.
3. It is requested that Public Works prepare correspondence to McKinmon, Edwards and Hitch architects indicating site plans are satisfactory and advising them to proceed with 35% submittal.

E. M. GLASS

Copy to:
Mr. Charlie Pye, Code LFF-1,
HQMC,
Washington, DC 20380

SECRET
NOV 1954

1. The purpose of this document is to provide information regarding the activities of the [redacted] in the [redacted] area. This information is being provided to you for your information and is not to be disseminated outside your agency.

2. The [redacted] has been identified as a [redacted] and is currently active in the [redacted] area. It is believed that this [redacted] is involved in the [redacted] of [redacted] and is a [redacted] of the [redacted] organization.


3. The [redacted] is believed to be a [redacted] of the [redacted] organization and is currently active in the [redacted] area. It is believed that this [redacted] is involved in the [redacted] of [redacted] and is a [redacted] of the [redacted] organization.

4. The [redacted] is believed to be a [redacted] of the [redacted] organization and is currently active in the [redacted] area. It is believed that this [redacted] is involved in the [redacted] of [redacted] and is a [redacted] of the [redacted] organization.


5. The [redacted] is believed to be a [redacted] of the [redacted] organization and is currently active in the [redacted] area. It is believed that this [redacted] is involved in the [redacted] of [redacted] and is a [redacted] of the [redacted] organization.

6. The [redacted] is believed to be a [redacted] of the [redacted] organization and is currently active in the [redacted] area. It is believed that this [redacted] is involved in the [redacted] of [redacted] and is a [redacted] of the [redacted] organization.


1. COMPONENT NAVY	FY 19 <u>79</u> MILITARY CONSTRUCTION PROJECT DATA	2. DATE 20 Oct 78
3. INSTALLATION AND LOCATION MARINE CORPS BASE, CAMP LEJEUNE, NORTH CAROLINA 28542		
4. PROJECT TITLE LOCATION EXCHANGE, AREAS 1 & 2	5. PROJECT NUMBER P-178	
<p><u>FACILITY STUDY</u></p> <p>1. <u>Project.</u> Provides a location exchange for personnel working and living in the area.</p> <p>2. <u>Current and Planned Future Workload with Regard to This Project.</u> The facilities will be utilized on an 8-hour day basis seven days a week. The duration of need for this facility is indefinite.</p> <p>3. <u>Description of Proposed Construction.</u></p> <p style="margin-left: 40px;">a. <u>Type of Construction.</u> One-story modular steel frame, reinforced concrete, special foundation, masonry walls, concrete floors, built-up roof, insulation, interior utility systems, rigid and flexible pavements, security lighting, utility connections, site improvement, etc.</p> <p style="margin-left: 40px;">b. <u>Replacement.</u> Not applicable.</p> <p style="margin-left: 40px;">c. <u>Description of Work to be Done.</u></p> <p style="margin-left: 80px;">(1) <u>Primary Facility.</u> Modular steel frame, reinforced concrete/masonry structure on special foundation.</p> <p style="margin-left: 80px;">(2) <u>Support Facility.</u> Pavements, lighting and site improvement.</p> <p style="margin-left: 80px;">(3) <u>Energy Conservation.</u> This project will utilize energy efficient equipment and building orientation for maximum energy conservation.</p> <p style="margin-left: 80px;">(4) <u>Collateral Equipment.</u></p> <p style="margin-left: 120px;">(a) <u>Built-in.</u> Venetian blinds, window screens and doors, drinking water coolers, telephone, fire alarm, sprinkler and intercom systems, plumbing, heating, ventilating and air conditioning systems. (The foregoing items are considered in the project cost estimate for the facility reflected on the 1391.)</p> <p style="margin-left: 120px;">(b) <u>Expense Items.</u> Will be nonappropriated fund supplied equipment.</p> <p style="margin-left: 80px;">(5) <u>Supporting Facilities.</u> Special foundation, pollution abatement, site improvements, etc.</p>		

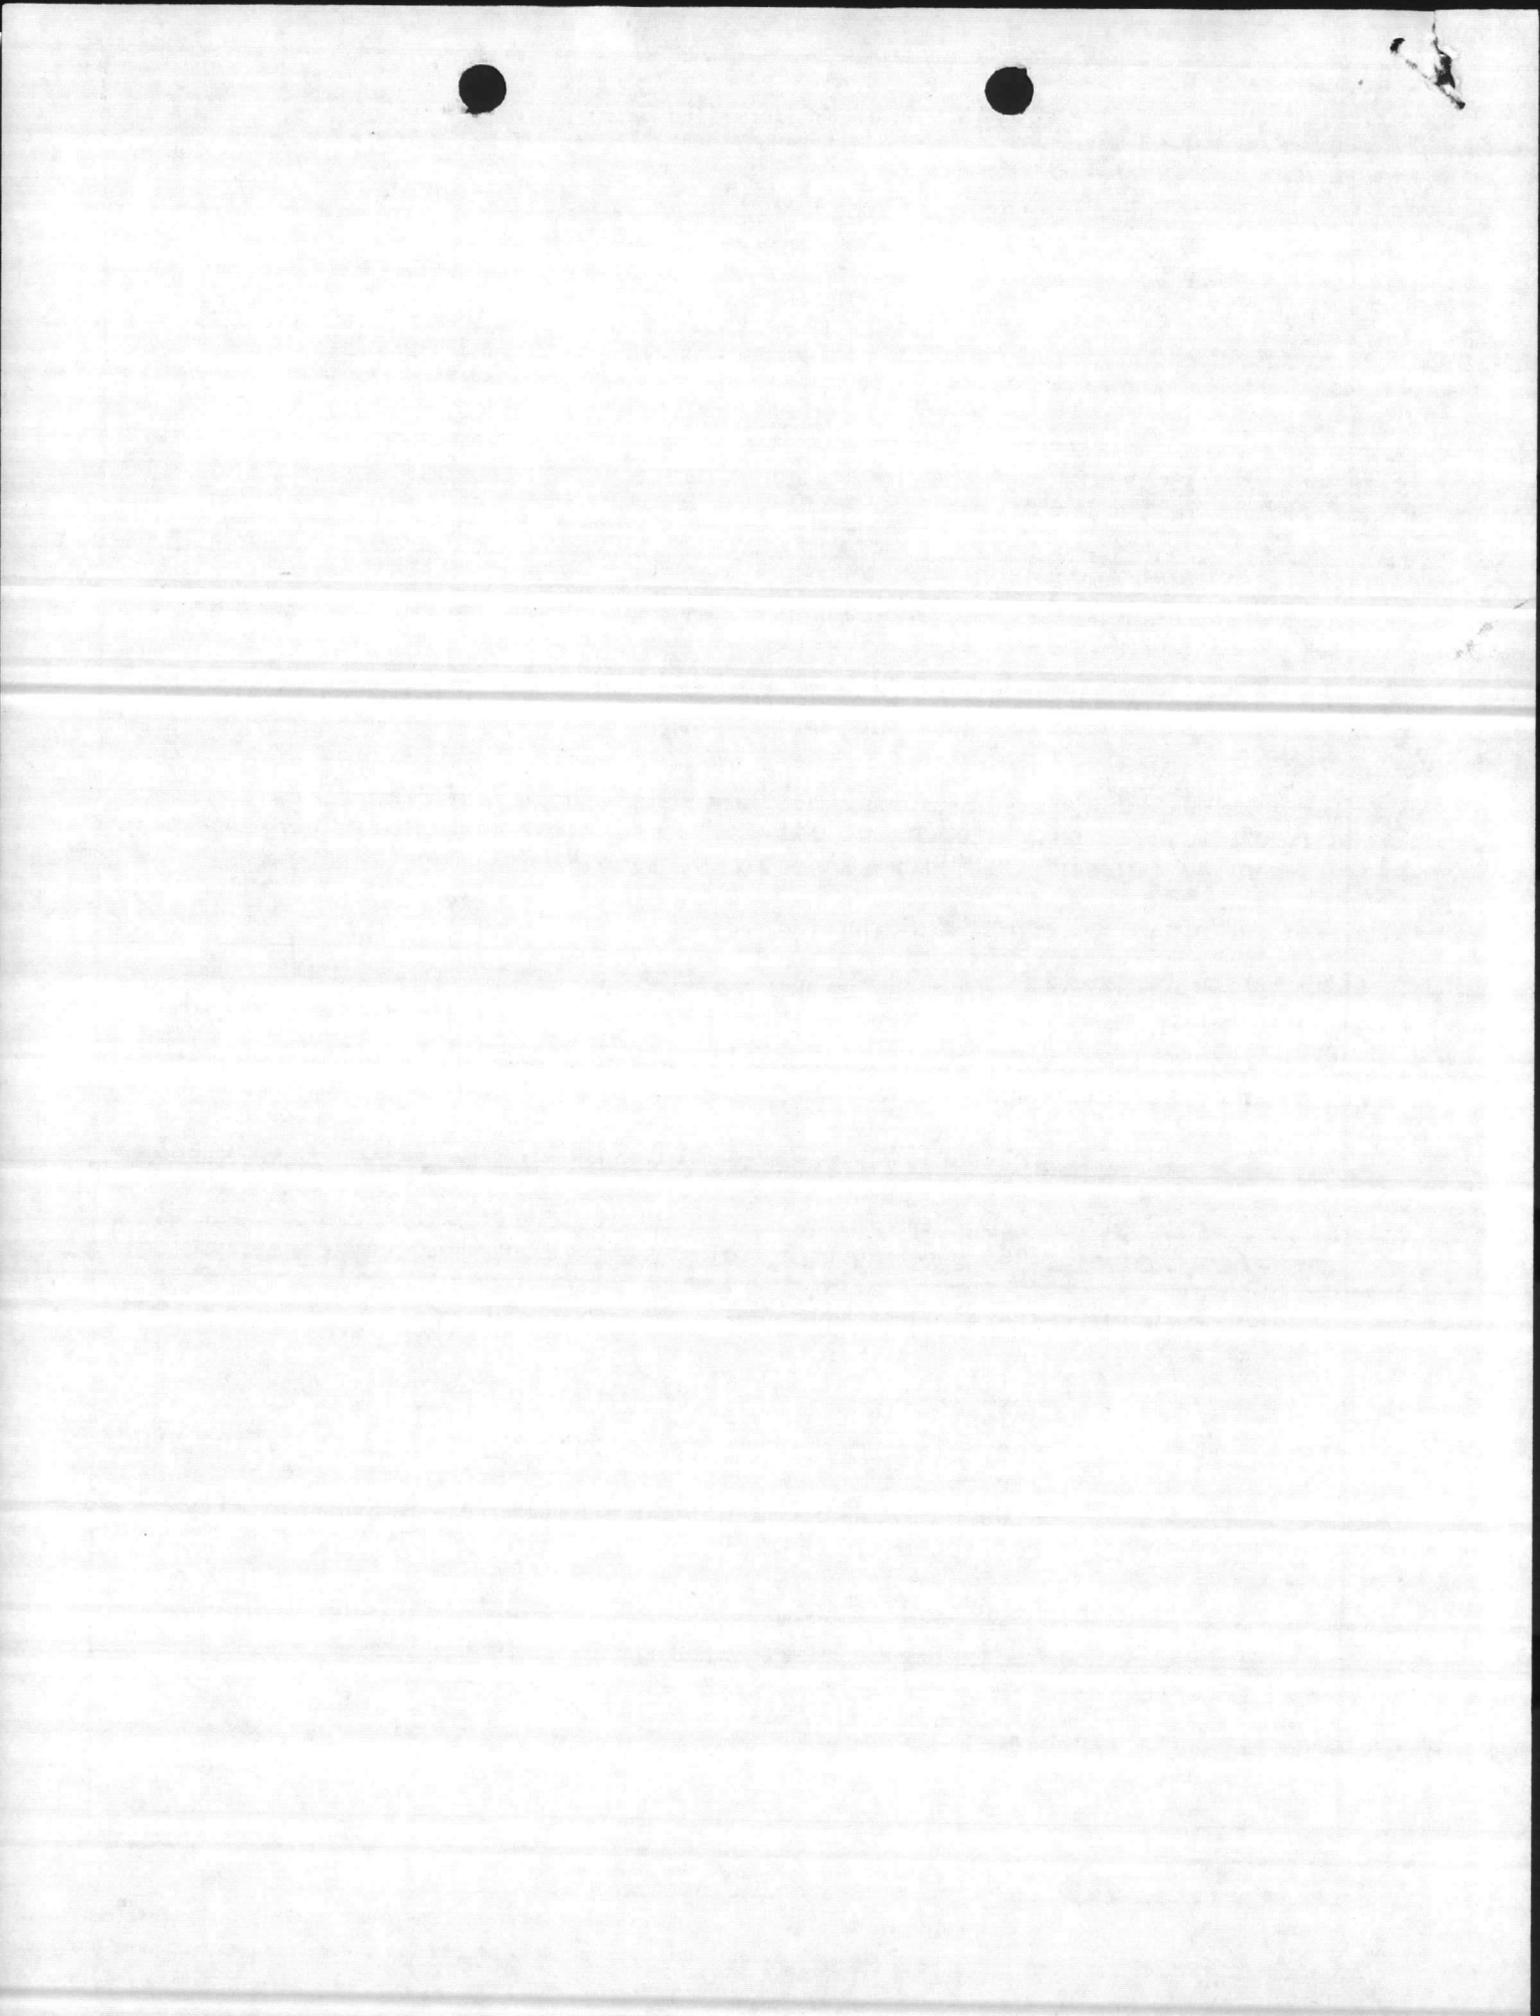

1. COMPONENT NAVY	FY 1979 MILITARY CONSTRUCTION PROJECT DATA	2. DATE 20 Oct 78
3. INSTALLATION AND LOCATION MARINE CORPS BASE, CAMP LEJEUNE, NORTH CAROLINA 28542		
4. PROJECT TITLE LOCATION EXCHANGE, AREAS 1 & 2	5. PROJECT NUMBER P-178	
<p>4. <u>Cost Estimates.</u> Area cost factor for Camp Lejeune, N. C. is 1.00, NAVFAC P-448 (Feb 1976), Military Construction Cost Engineering Data. The book data is escalated to provide the cost for the proposed facility. The contingency factor is 10% and the cost growth factor is computed at 10% per year for the project.</p> <p>5. <u>Justification for Project and for Scope of Project.</u></p> <p>a. <u>Justification for Project.</u></p> <p>(1) <u>Project.</u> Proposed facility is required for troops and personnel living and working in close proximity to the proposed location exchange.</p> <p>(2) <u>Current Situation.</u> Location exchanges are in substandard and minimum facilities located in or near personnel centers.</p> <p>(3) <u>Impact if Not Provided.</u> Personnel will continue to utilize substandard and minimum facilities which provide inefficient operations and limited services to patrons.</p> <p>b. <u>Justification for Scope of Project.</u></p> <p>(1) The project scope is the minimum size facility that can meet the deficiency requirements for space, Category Code 740-02 (Location Exchange). This will correct the deficiency in the area. See Item 13., Quantitative Data.</p> <p>6. <u>Equipment Provided from Other Appropriations.</u> Not applicable.</p> <p>7. <u>Common Support Facilities.</u> Not applicable. There are no common support facilities available in the area.</p> <p>8. <u>Effect on Other Resources.</u> The project will require approximately \$4,315.00 per year in increased O&MN funds for increased utility services and operations. No additional personnel will be required to operate this facility. The project will enhance and improve the morale of personnel presently working and living in the vicinity. Proposed construction should be responsive to the challenges presented by the energy situation, and comply with the requirements of Executive Order 12003 of 20 July 1977 and implemented by NAVFACINST 4100.5A.</p>		

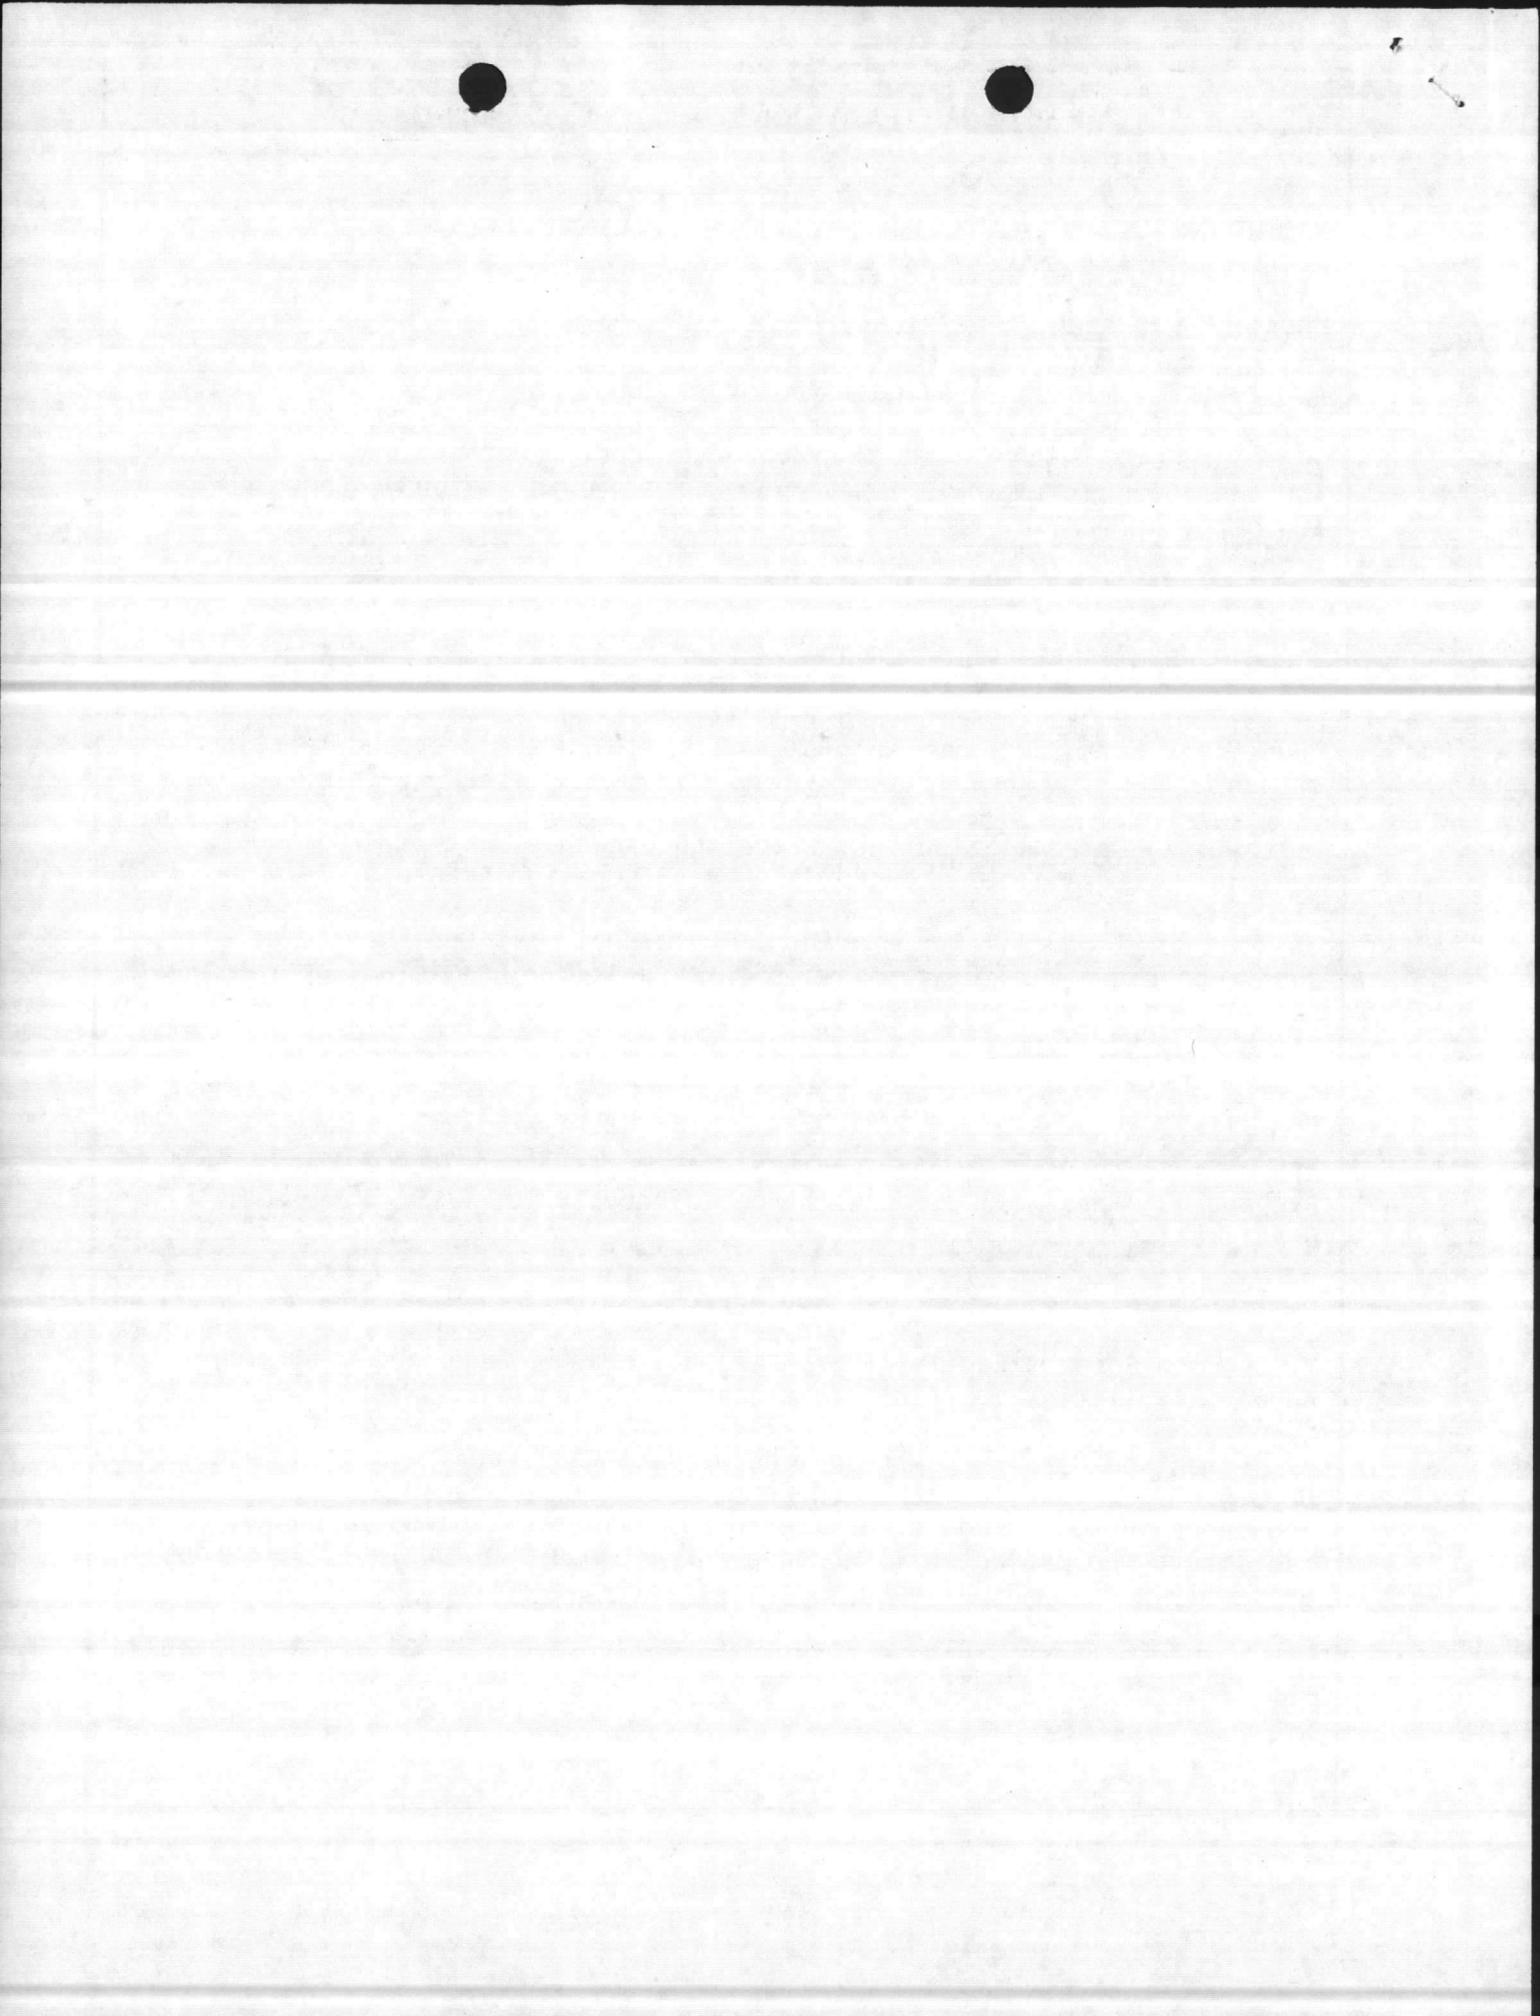

1. COMPONENT NAVY	FY 19 <u>69</u> MILITARY CONSTRUCTION PROJECT DATA	2. DATE 20 Oct 78																								
3. INSTALLATION AND LOCATION MARINE CORPS BASE, CAMP LEJEUNE, NORTH CAROLINA 28542																										
4. PROJECT TITLE LOCATION EXCHANGE, AREAS 1 & 2		5. PROJECT NUMBER P-178																								
<p style="text-align: center;">UTILITY REQUIREMENTS</p> <p>a. Electricity</p> <table style="margin-left: 100px;"> <tr> <td>Consumption</td> <td style="text-align: right;">62,280</td> <td style="text-align: right;">KWHR/yr</td> </tr> <tr> <td>Peak Demand</td> <td style="text-align: right;">36</td> <td style="text-align: right;">KW</td> </tr> <tr> <td>Avg Demand</td> <td style="text-align: right;">31</td> <td style="text-align: right;">KW</td> </tr> </table> <p>b. Steam</p> <table style="margin-left: 100px;"> <tr> <td>Consumption</td> <td style="text-align: right;">958,716</td> <td style="text-align: right;">lbs/yr</td> </tr> <tr> <td>Demand</td> <td style="text-align: right;">343</td> <td style="text-align: right;">lbs/hr</td> </tr> </table> <p>c. Coal</p> <table style="margin-left: 100px;"> <tr> <td></td> <td style="text-align: right;">37.4</td> <td style="text-align: right;">tons/yr</td> </tr> </table> <p>d. Adequate utility requirements are available.</p> <p>9. <u>Siting of the Project.</u></p> <p>a. <u>Building layout.</u> See enclosure (1).</p> <p>b. <u>Location.</u> See enclosure (2).</p> <p>10. <u>Other Graphic Presentations, including Photographs.</u> None.</p> <p>11. <u>Economic Analysis.</u> The facility is being constructed in a developed area of the Base and the economic saving will be in nominal energy consumption savings to be realized from efficient operations. This is not an operational project requirement.</p> <p>12. <u>Environmental Impact.</u> The project will not cause any additional air or water pollution and energy conservation measures and features have been considered to enhance the design and economics of the facility.</p> <p>13. <u>Quantitative Data.</u></p> <p>a. <u>BFRL Requirement.</u> NAVFAC P-80 allowance factors for a location exchange were used for the Hadnot Point area of the Base. The total BFRL requirement is 32,717 SF.</p> <p>b. <u>Existing Assets.</u> ADEQUATE: 3,525 SF. SUBSTD: 19,151 SF.</p> <table style="margin-left: 100px;"> <thead> <tr> <th style="text-align: left;"><u>Building No.</u></th> <th style="text-align: left;"><u>Area SF</u></th> <th style="text-align: left;"><u>Disposition</u></th> </tr> </thead> <tbody> <tr> <td style="text-align: center;">4</td> <td style="text-align: center;">3,333</td> <td style="text-align: center;">To be retained.</td> </tr> </tbody> </table>			Consumption	62,280	KWHR/yr	Peak Demand	36	KW	Avg Demand	31	KW	Consumption	958,716	lbs/yr	Demand	343	lbs/hr		37.4	tons/yr	<u>Building No.</u>	<u>Area SF</u>	<u>Disposition</u>	4	3,333	To be retained.
Consumption	62,280	KWHR/yr																								
Peak Demand	36	KW																								
Avg Demand	31	KW																								
Consumption	958,716	lbs/yr																								
Demand	343	lbs/hr																								
	37.4	tons/yr																								
<u>Building No.</u>	<u>Area SF</u>	<u>Disposition</u>																								
4	3,333	To be retained.																								

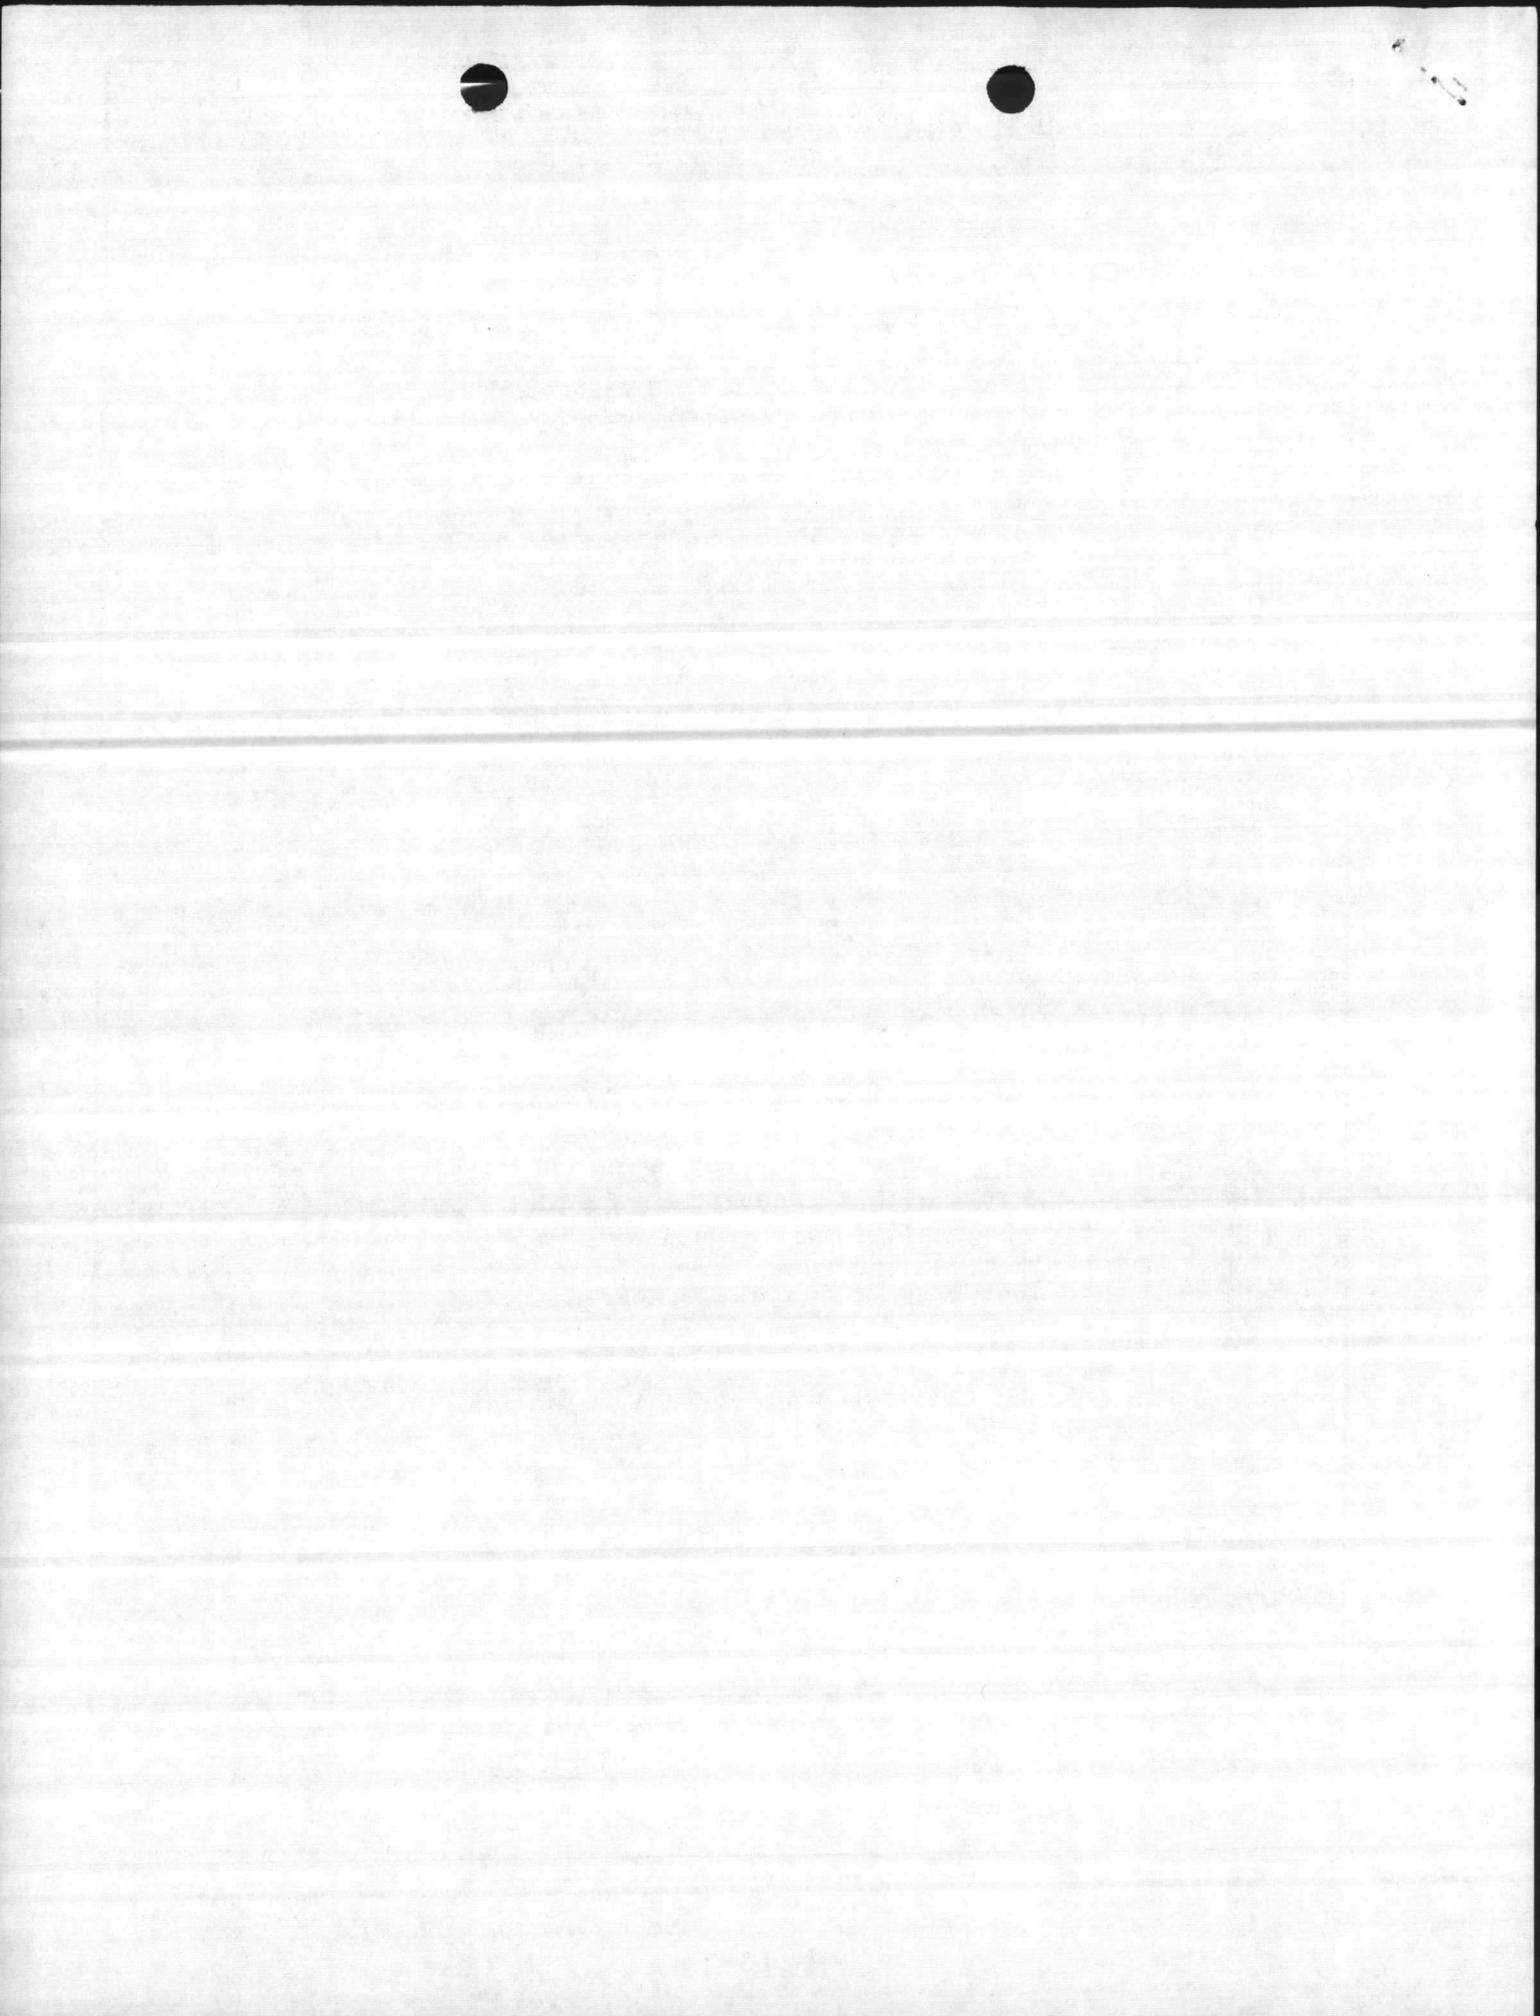

1. COMPONENT NAVY	FY 19⁷⁹ MILITARY CONSTRUCTION PROJECT DATA	2. DATE 20 Oct 78
3. INSTALLATION AND LOCATION MARINE CORPS BASE, CAMP LEJEUNE, NORTH CAROLINA 28542		
4. PROJECT TITLE LOCATION EXCHANGE, AREAS 1 & 2		5. PROJECT NUMBER P-178

<u>Building No.</u>	<u>Area SF</u>	<u>Disposition</u>
4A	192	To be retained.
125*	3,950	Substd./converted to other use.
225*	3,870	" " "
403	3,333	" " "
403A*	192	" " "
524*	4,566	" " "
1207	3,240	" " "
	<u>22,676</u>	

* These facilities are reflected incorrectly, as adequate, and will be changed to substandard on the next update of the Marine Corps Form 10651.

c. Planned Facilities.


<u>FY</u>	<u>Project No.</u>	<u>Area SF</u>	<u>Location</u>
79	P-178	8,100	Areas 1 & 2
80	P-724	8,100	Areas 4 & 5
82	P-431	7,210	Industrial Area
UP	-	5,782	-
		<u>29,192</u>	Total Planned Facilities

14. Funding. Funding will be from the Non-appropriated Fund, Central Construction Fund, HQMC.



1. COMPONENT NAVY		FY 1979 MILITARY CONSTRUCTION PROJECT DATA NONAPPROPRIATED FUND		2. DATE 29 Aug 1978	
3. INSTALLATION AND LOCATION MARINE CORPS BASE CAMP LEJEUNE, NORTH CAROLINA 28542			4. PROJECT TITLE LOCATION EXCHANGE, AREAS 1 & 2		
5. PROGRAM ELEMENT		6. CATEGORY CODE 740-02	7. PROJECT NUMBER P-178	8. PROJECT COST (\$000) 411	
9. COST ESTIMATES					
ITEM		U/M	QUANTITY	UNIT COST	COST (\$000)
LOCATION EXCHANGE W/SPECIAL FNDN		SF	8,100	33.58	272
UTILITIES: WATER, ELEC, SEWER, STEAM		LS	-	-	31
PAVEMENT, FLEXIBLE & RIGID		LS	-	-	19
SITE IMPROVEMENTS/EROSION CONTROL		LS	-	-	15
SUBT. COST		LS	-	-	337
CONTINGENCY - 10%		LS	-	-	33
ESTIMATED CONTRACT COST		LS	-	-	370
SUPERVISION, INSPECTION & OVERHEAD - 5.5%		LS	-	-	19
TOTAL REQUEST		LS	-	-	389
INSTALLED EQUIP OTHER APPROPRIATIONS		-	-	-	-
A & E DESIGN FEE - 6 %		LS	-	-	22
PROJECT COST		LS	-	-	411
10. DESCRIPTION OF PROPOSED CONSTRUCTION					
Single story structure with reinforced concrete foundation and floor, brick veneer masonry walls, built up roof, insulation, air conditioning/heat pump system, utilities connected, pavements, and site improvements.					
11. REQUIREMENTS 32,717 SF. ADEQUATE: 15,911 SF. SUBSTD 22,676 SF.					
PROJECT: Provide a location exchange with snack bar, dry cleaning pick up station, barber shop, utilities, pavements, and site improvement for personnel in the First and Second Areas.					
REQUIREMENT: An exchange is required to provide personnel of the 2d Marine Division located in the First and Second Areas an Exchange close to their barracks and work areas.					
CURRENT SITUATION: Minimum exchange functions are being provided in a small section of a Service Club constructed in 1942.					
IMPACT IF NOT PROVIDED: Personnel will be compelled to use inadequate exchange facilities and/or travel or walk to the main exchange which is some distance from the First and Second Areas.					

ENCLOSURE (1)

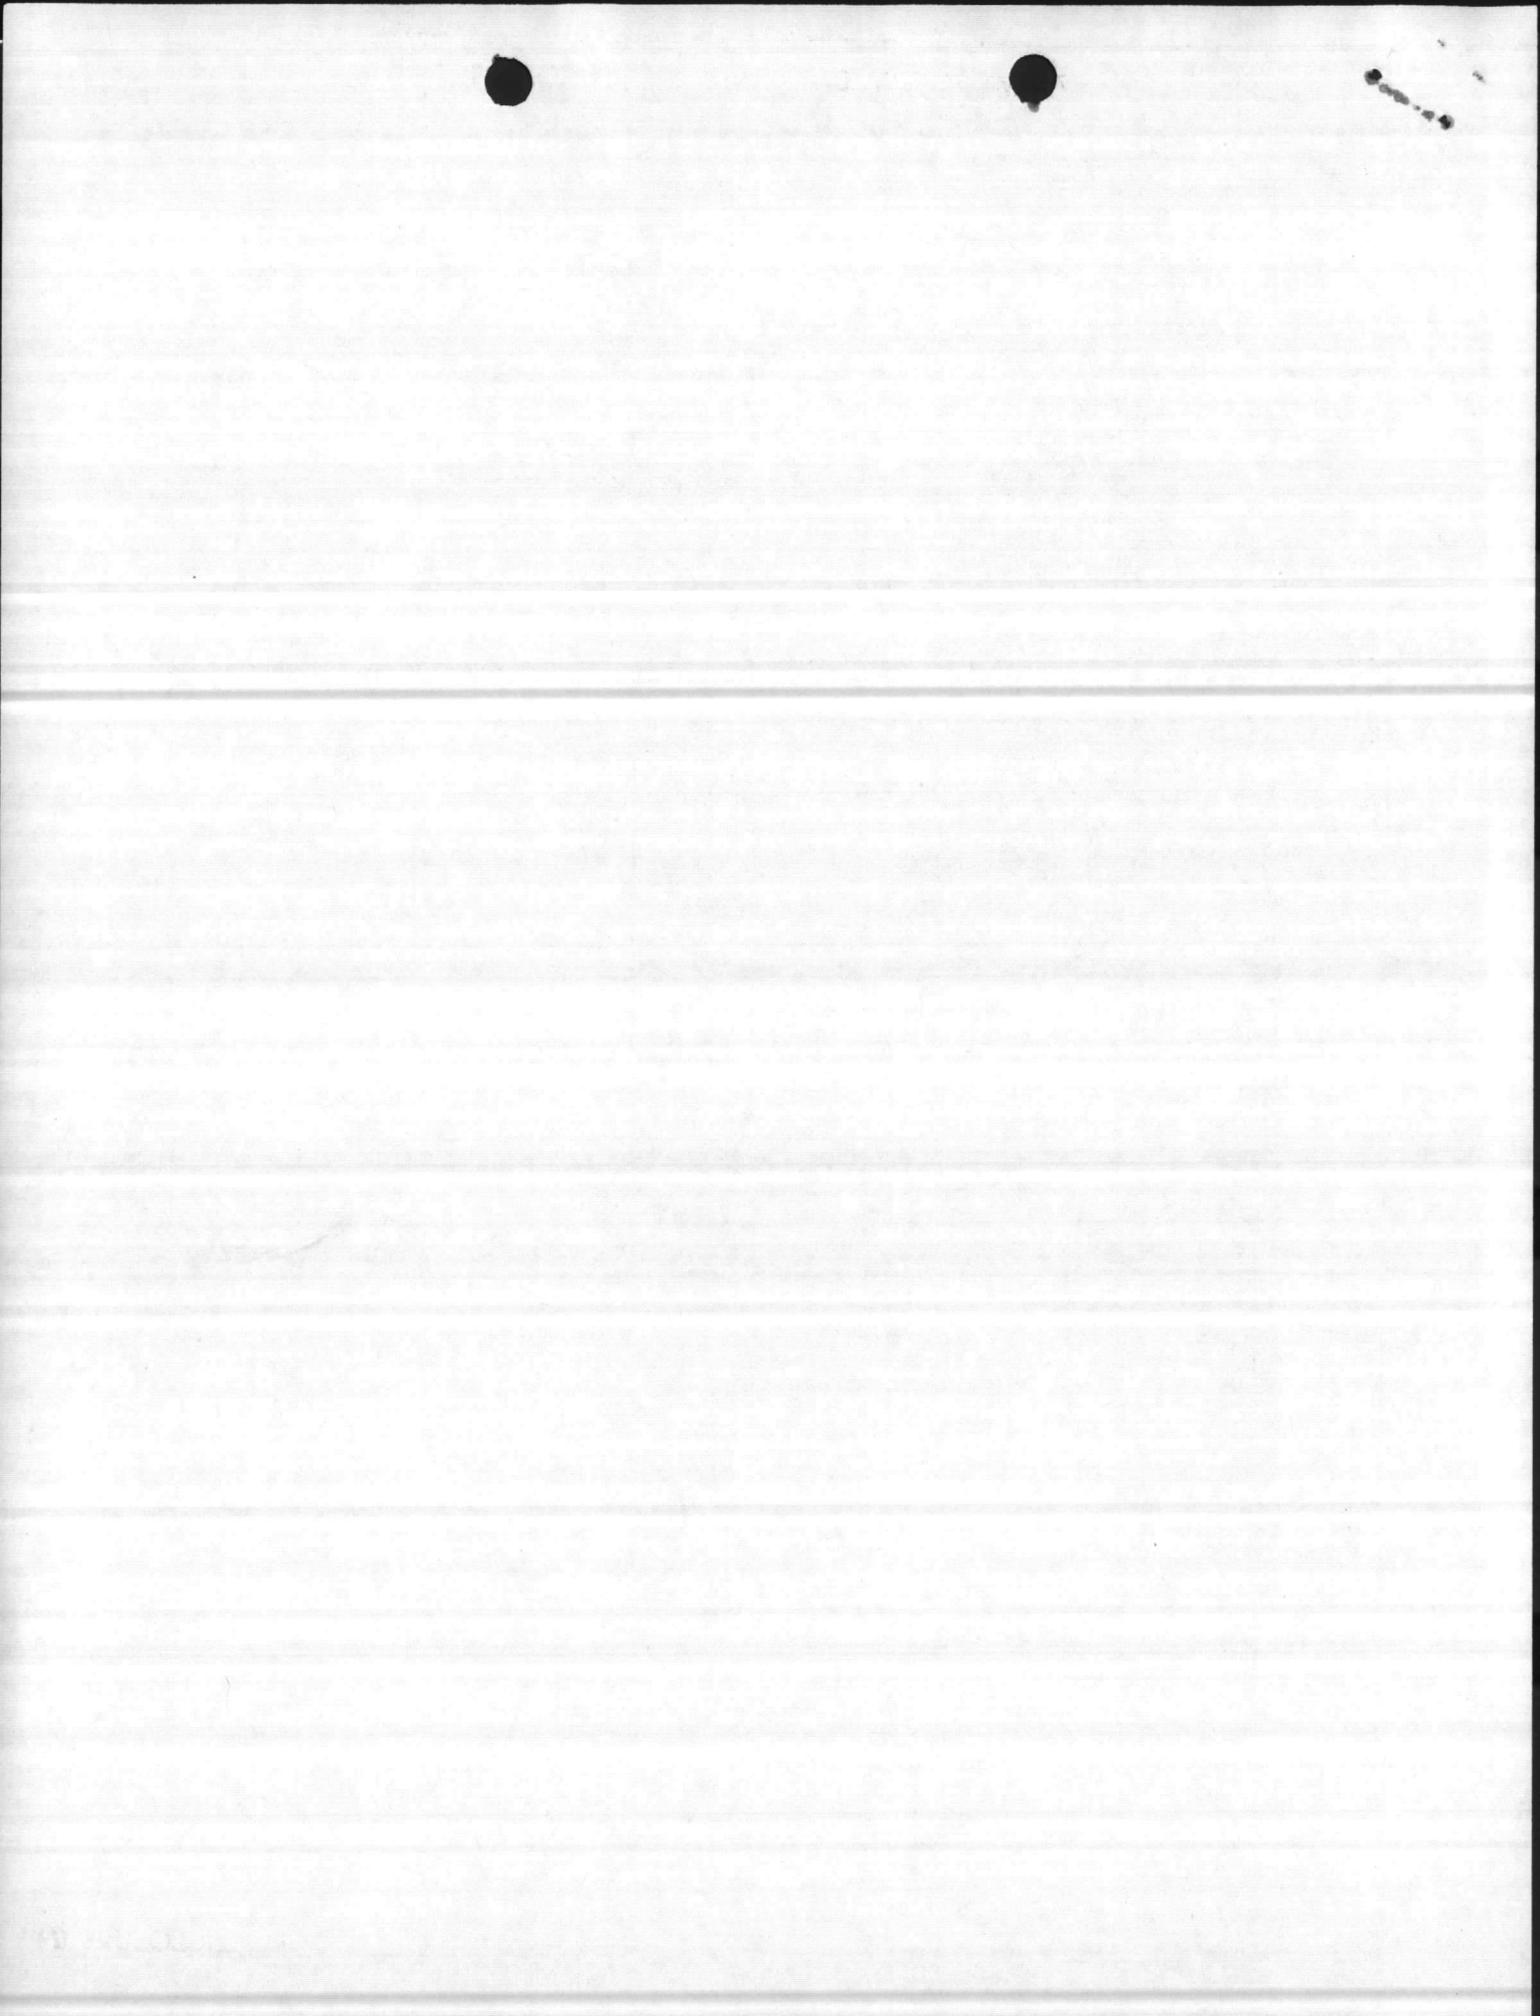

COMPONENT

FY 1978 MILITARY CONSTRUCTION PROJECT DATA

2. DATE

NAVY

29 Aug 78

3. INSTALLATION AND LOCATION

MARINE CORPS BASE, CAMP LEJEUNE, NORTH CAROLINA 28542

4. PROJECT TITLE


LOCATION EXCHANGE, AREAS 1 AND 2

5. PROJECT NUMBER

P-178

SPECIAL CONSIDERATIONS

1. ENVIRONMENTAL IMPACT. An environmental impact assessment has been made and it has been determined that the proposed project will have neither a significant impact on the environment nor is it highly controversial.
2. PRESERVATION OF HISTORICAL SITES AND STRUCTURES. The project facilities do not directly or indirectly affect a district, site, building, structure, object, or setting which is listed in the National Register or otherwise possesses a significant quality of American history.
3. FALLOUT SHELTER CONSTRUCTION. Fallout shelter excluded - impairment of project purpose.
4. FLOOD HAZARDS. Requirements of Executive Order No. 11296 (Flood Hazards) are not applicable.
5. POLLUTION PREVENTION, ABATEMENT, AND CONTROL. This project will not cause additional air or water pollution.
6. DESIGN FOR ACCESSIBILITY OF PHYSICALLY HANDICAPPED PERSONNEL. Consideration shall be given for accessibility of physically handicapped personnel.
7. USE OF AIR CONDITIONING. Ceiling "U" factors will be made to conform with DOD 4270.1-M.

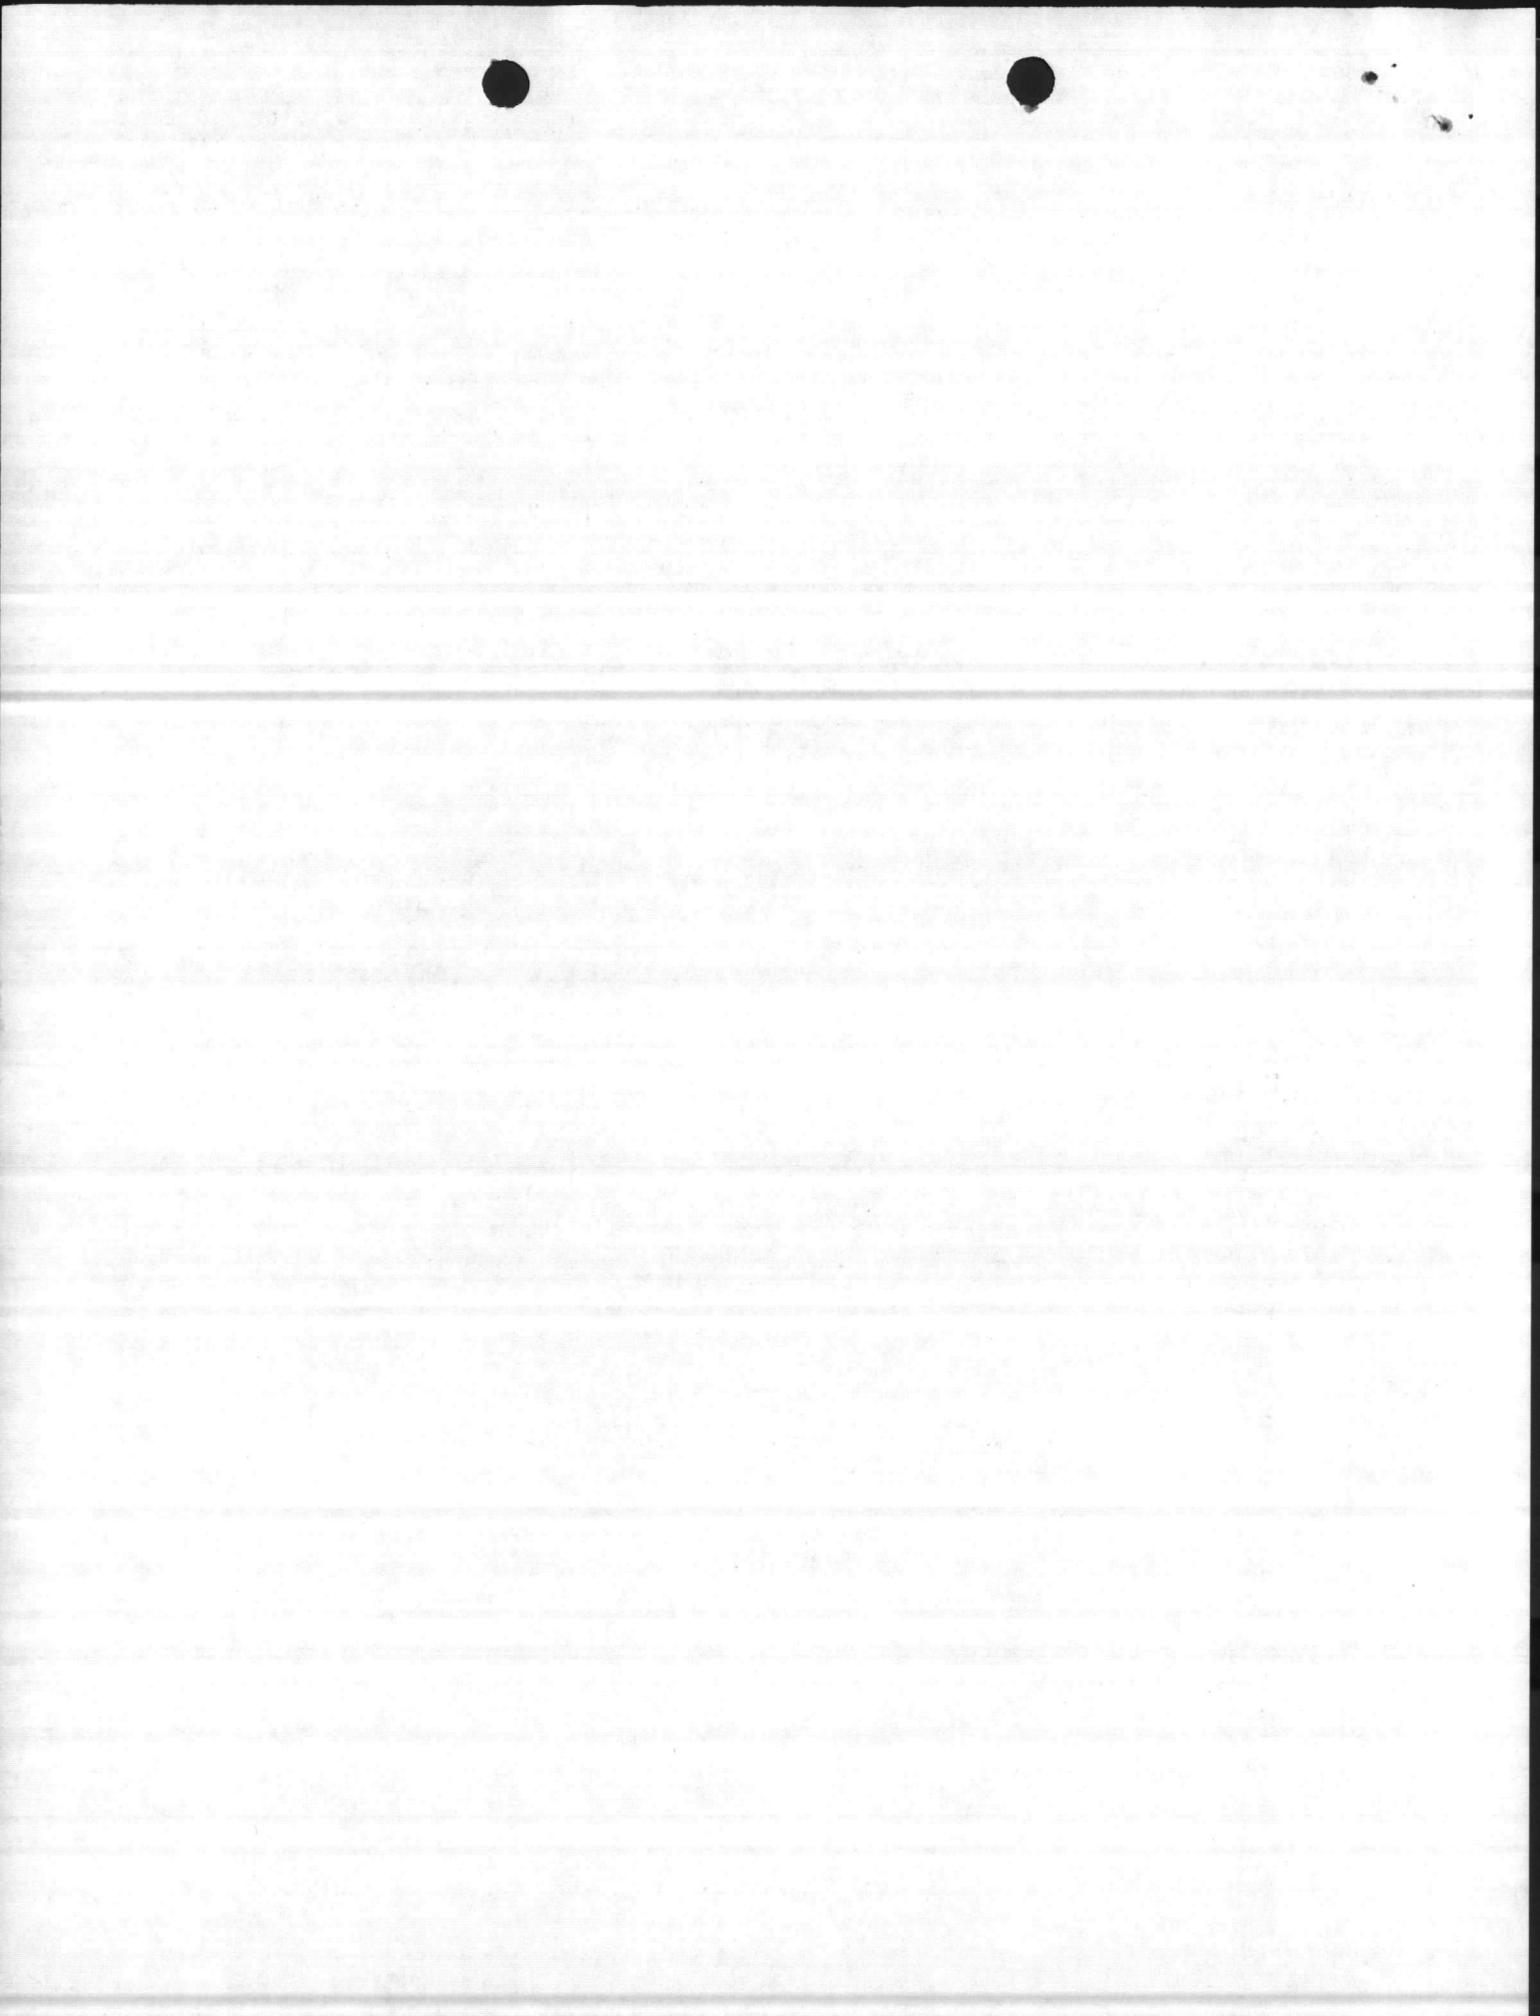

0105 013 3800

IDENTIFICATION NUMBER

P-178

AREA OR NO

ACTIVITY

LOCATION

CATEGORY CODE NUMBER

5th ND

MARINE CORPS BASE


CAMP LEJEUNE, N.C.

740-02

PROJECT (Or line item) TITLE

LOCATION EXCHANGE, AREAS 1 & 2

ITEM (OR FEATURE) DESCRIPTION (Abbreviate if necessary)	QUANTITIES		MATERIAL COSTS		LABOR COSTS		ENGINEERING ESTIMATE	
	NO. OF UNITS	UNIT	UNIT COST	COST	UNIT COST	COST	UNIT COST	COST
1	2	3	4	5	6	7	8	9
4"Reinf. conc. slab, ftgs, piling, etc.		LS		9,525		3,100		12,625
Brick, face, sand/clay CMU, 6" w/insulation	46,300	EA	.13	6,019	.40	18,520	.53	24,539
Insul, wall, rigid	2,900	EA	.47	1,363	1.23	3,567	1.70	4,930
Bar joist	2,100	SF	.32	672	.16	336	.48	1,008
Struct. stl.	6	TN	597.	3,582	142.	852	739.	4,434
Col., stl. pipe, 4"	7	TN	610.	4,270	153.	1,071	763.	5,341
Deck, mtl., roof	1,200	LB	.33	396	.09	108	.42	504
Roof, built-up	8,100	SF	.66	5,346	.49	3,969	1.15	9,315
Flashing, copper	80	SQ	44.	3,520	23.	1,840	67.	5,360
Insul., rigid, 2"	620	SF	1.85	1,147	1.25	775	3.10	1,922
Tile, accoust., clg.	8,100	SF	.53	4,293	.27	2,187	.80	6,480
Insul., batt, clg.	8,100	SF	.89	7,209	.49	3,969	1.38	11,178
Tile, vinyl asb.	8,100	SF	.49	3,969	.26	2,106	.75	6,075
Hemgatile Fl.	3,480	SF	.83	2,888	.36	1,253	1.19	4,141
Dr., entr., al., dbl., w/frames & hdw.	4,620	SF	1.09	5,036	.71	3,280	1.80	8,316
Dr., H.M., ext., dbl., w/frames & hdw.	5	EA	873.	4,365	125.	625	998.	4,990
Dr., H.M., int.	4	EA	523.	2,092	127.	508	650.	2,600
Partitions, wall, int.	10	EA	148	1,480	97.	970	245.	2,450
Stalls, mtl., toilet	260	LF	10.00	2,600	11.00	2,860	21.00	5,460
Downspout, mtl. copper	8	EA	185.	1,480	65.	520	250.	2,000
Scuppers, mtl. copper	170	LF	5.05	859	.65	111	5.70	970
Canopy, al., 6"	14	EA	60.	840	22.00	308	82.00	1,148
Painting	130	LF	10.10	1,313	7.05	917	17.15	2,230
	5,100	SF	.13	633	.33	1,683	.46	2,346
<u>Electrical</u>								
Transf. 150 KVA w/accys 400 Amp. pnls & pnl., lgt, w/bkrs, etc.	2	EA	3,650.	7,300	766.	1,532	4,416	8,832
Fluor. fix, 4T96	3	LS	925.	2,775	130.	390	1,055	3,165
Recept., elect.	95	EA	95.	9,025	23.	2,185	118.	11,210
MV fix., ext. w/pole	65	EA	5.	325	7.	455	12.	780
Misc. wiring & cond.	10	EA	460.	4,600	305.	3,050	765.	7,650
Fire protection system lights & alarm		LS		1,780		3,420		5,200
				3,115		1,950		5,065

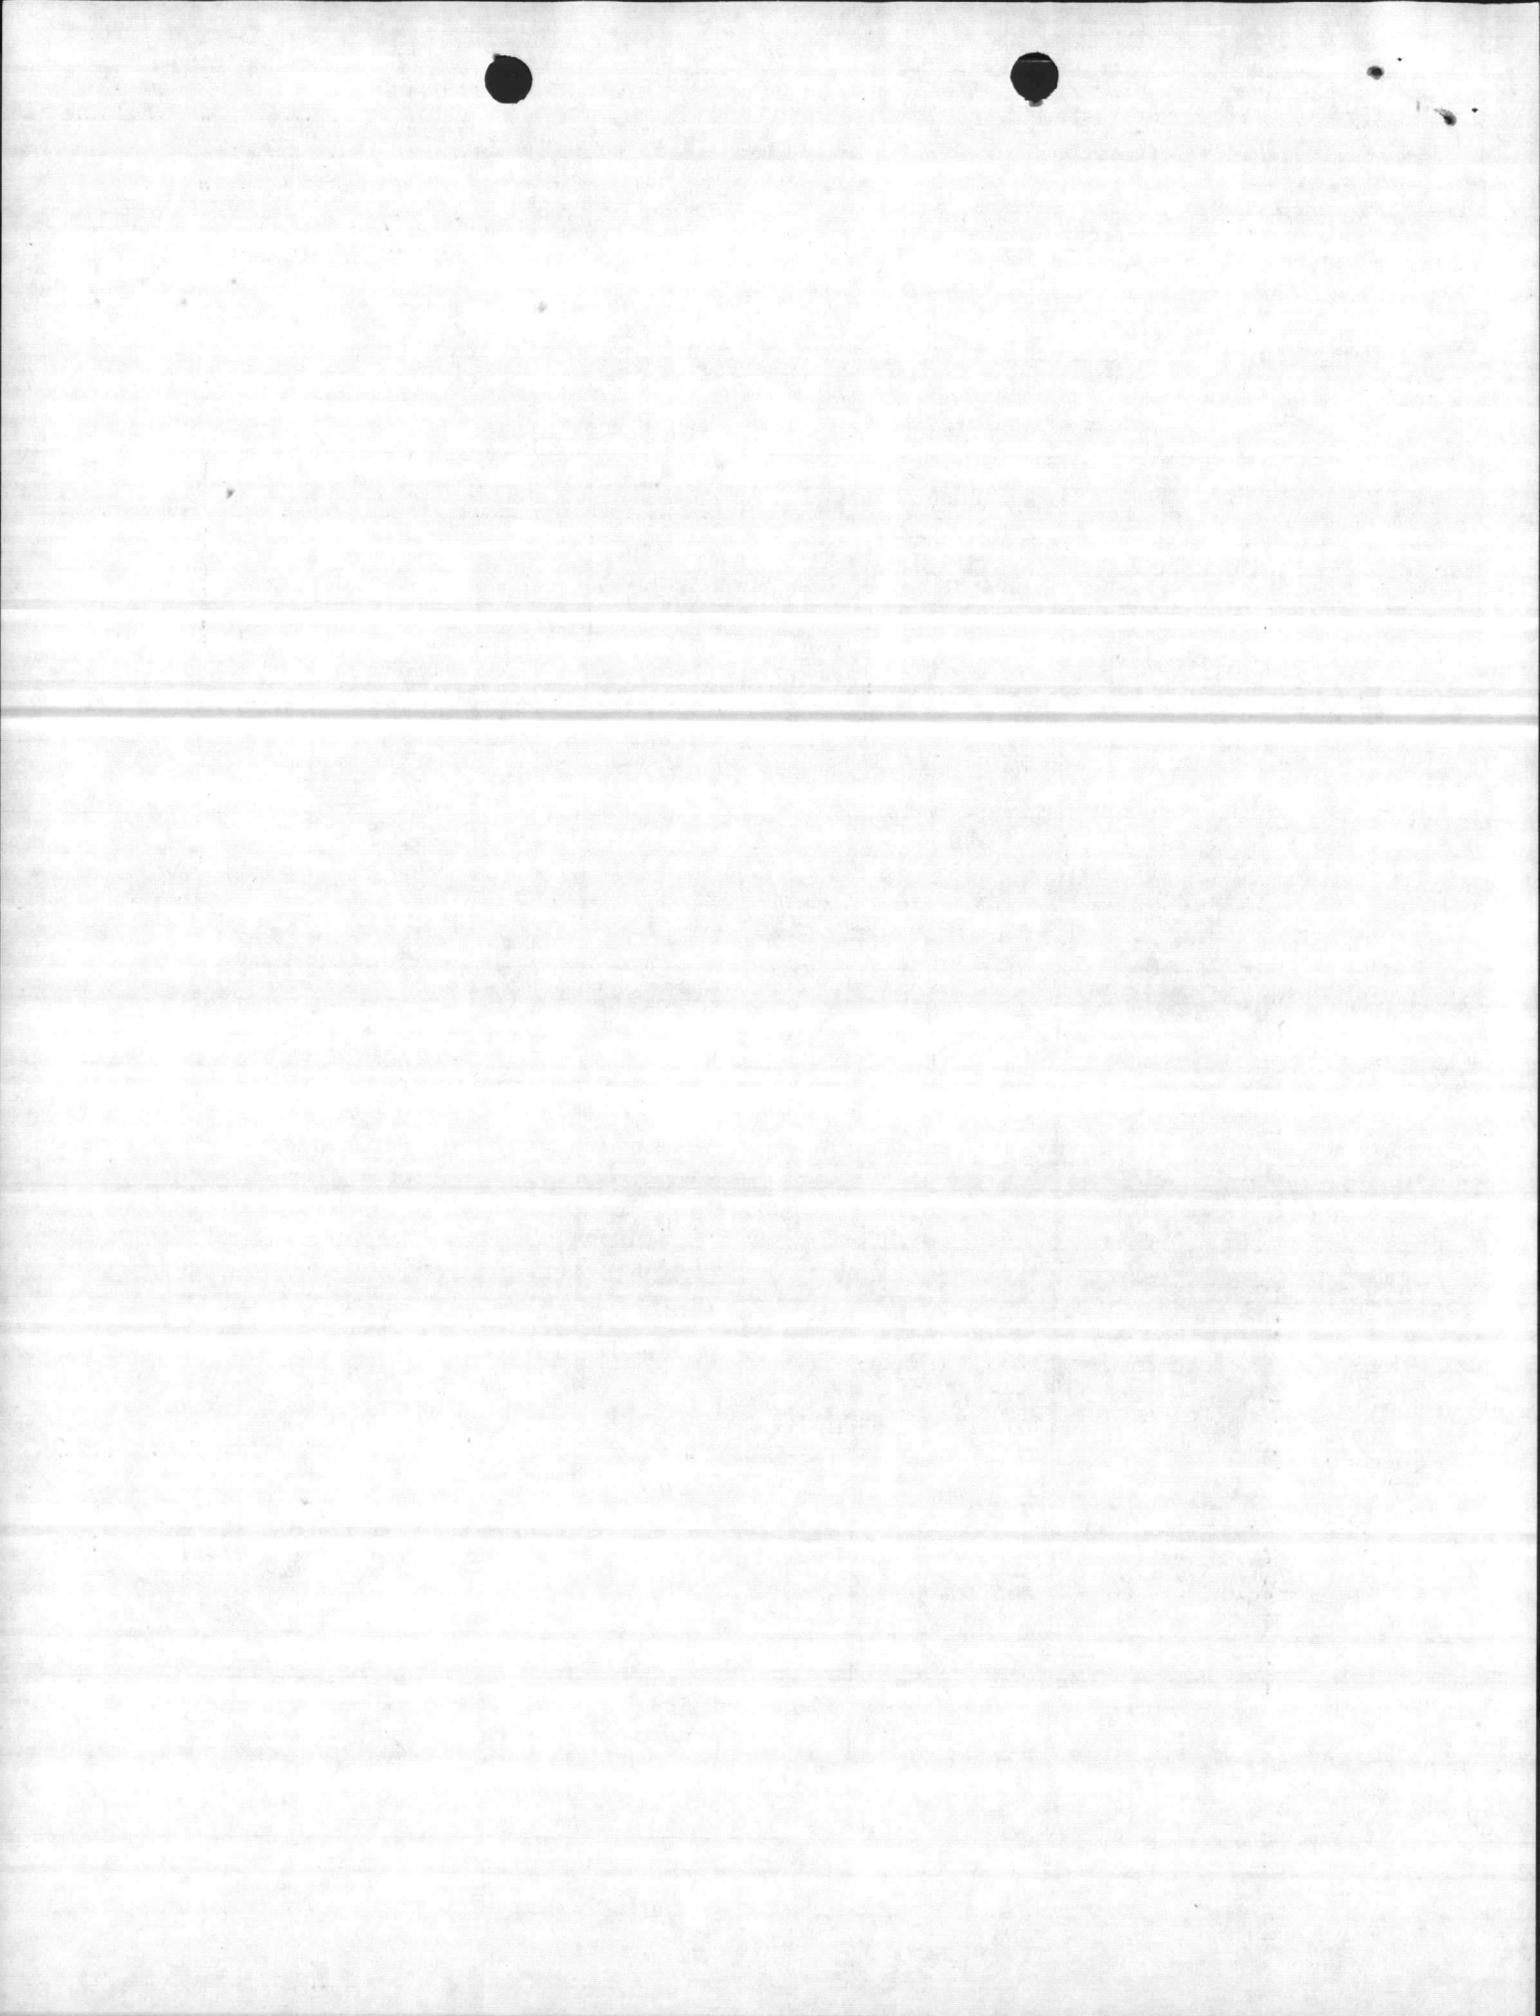

0105 013 3600


IDENTIFICATION NUMBER
 P-178


AREA OR NO 5th ND	ACTIVITY MARINE CORPS BASE	LOCATION CAMP LEJEUNE, N.C.	CATEGORY CODE NUMBER 740-02
----------------------	-------------------------------	--------------------------------	--------------------------------

PROJECT (Or line item) TITLE

LOCATION EXCHANGE, AREAS 1 & 2

ITEM (OR FEATURE) DESCRIPTION (Abbreviate if necessary)	QUANTITIES		MATERIAL COSTS		LABOR COSTS		ENGINEERING ESTIMATE	
	NO. OF UNITS	UNIT	UNIT COST	COST	UNIT COST	COST	UNIT COST	COST
1	2	3	4	5	6	7	8	9
<u>Heat., A/C & Vent</u>								
35 TN heat pump, controls, resistor coils w/insulated duct, diff. & grilles		LS		27,060		13,350		40,410
Exh. fan, w/hood	5	EA	378	1,890	97	485	475	2,375
<u>Plumbing</u>								
Toilet fix. w/piping	5	EA	245	1,225	245	1,225	490	2,450
Fl. drains w/piping	9	EA	185	1,665	125	1,125	310	2,790
Elect. drink ftn. & acc.	3	EA	380	1,140	130	390	510	1,530
Hot water heater, storage, 1,000 gal.	1	EA		2,720		305		3,025
<u>Site Work</u>								
Paving, sub-base, grading & escav.		LS		7,200		6,360		13,560
Utilities to site location		LS		8,500		5,500		14,000
				155,247		97,157		252,404
SUBTOTALS								37,861
OVERHEAD - 15%								11,659
INS., TAXES, ETC. - 12% LABOR								301,924
SUBTOTAL								30,192
PROFIT - 10%								332,116
SUBTOTAL								4,982
BOND - 1.0%								337,098
SUBTOTAL								33,710
CONTINGENCY - 10%								370,808
SUBTOTAL								18,540
S.I.O.H. 5.5%								389,348
TOTAL PROJECT ESTIMATE								22,000
A & E DESIGN FEE - 6%								

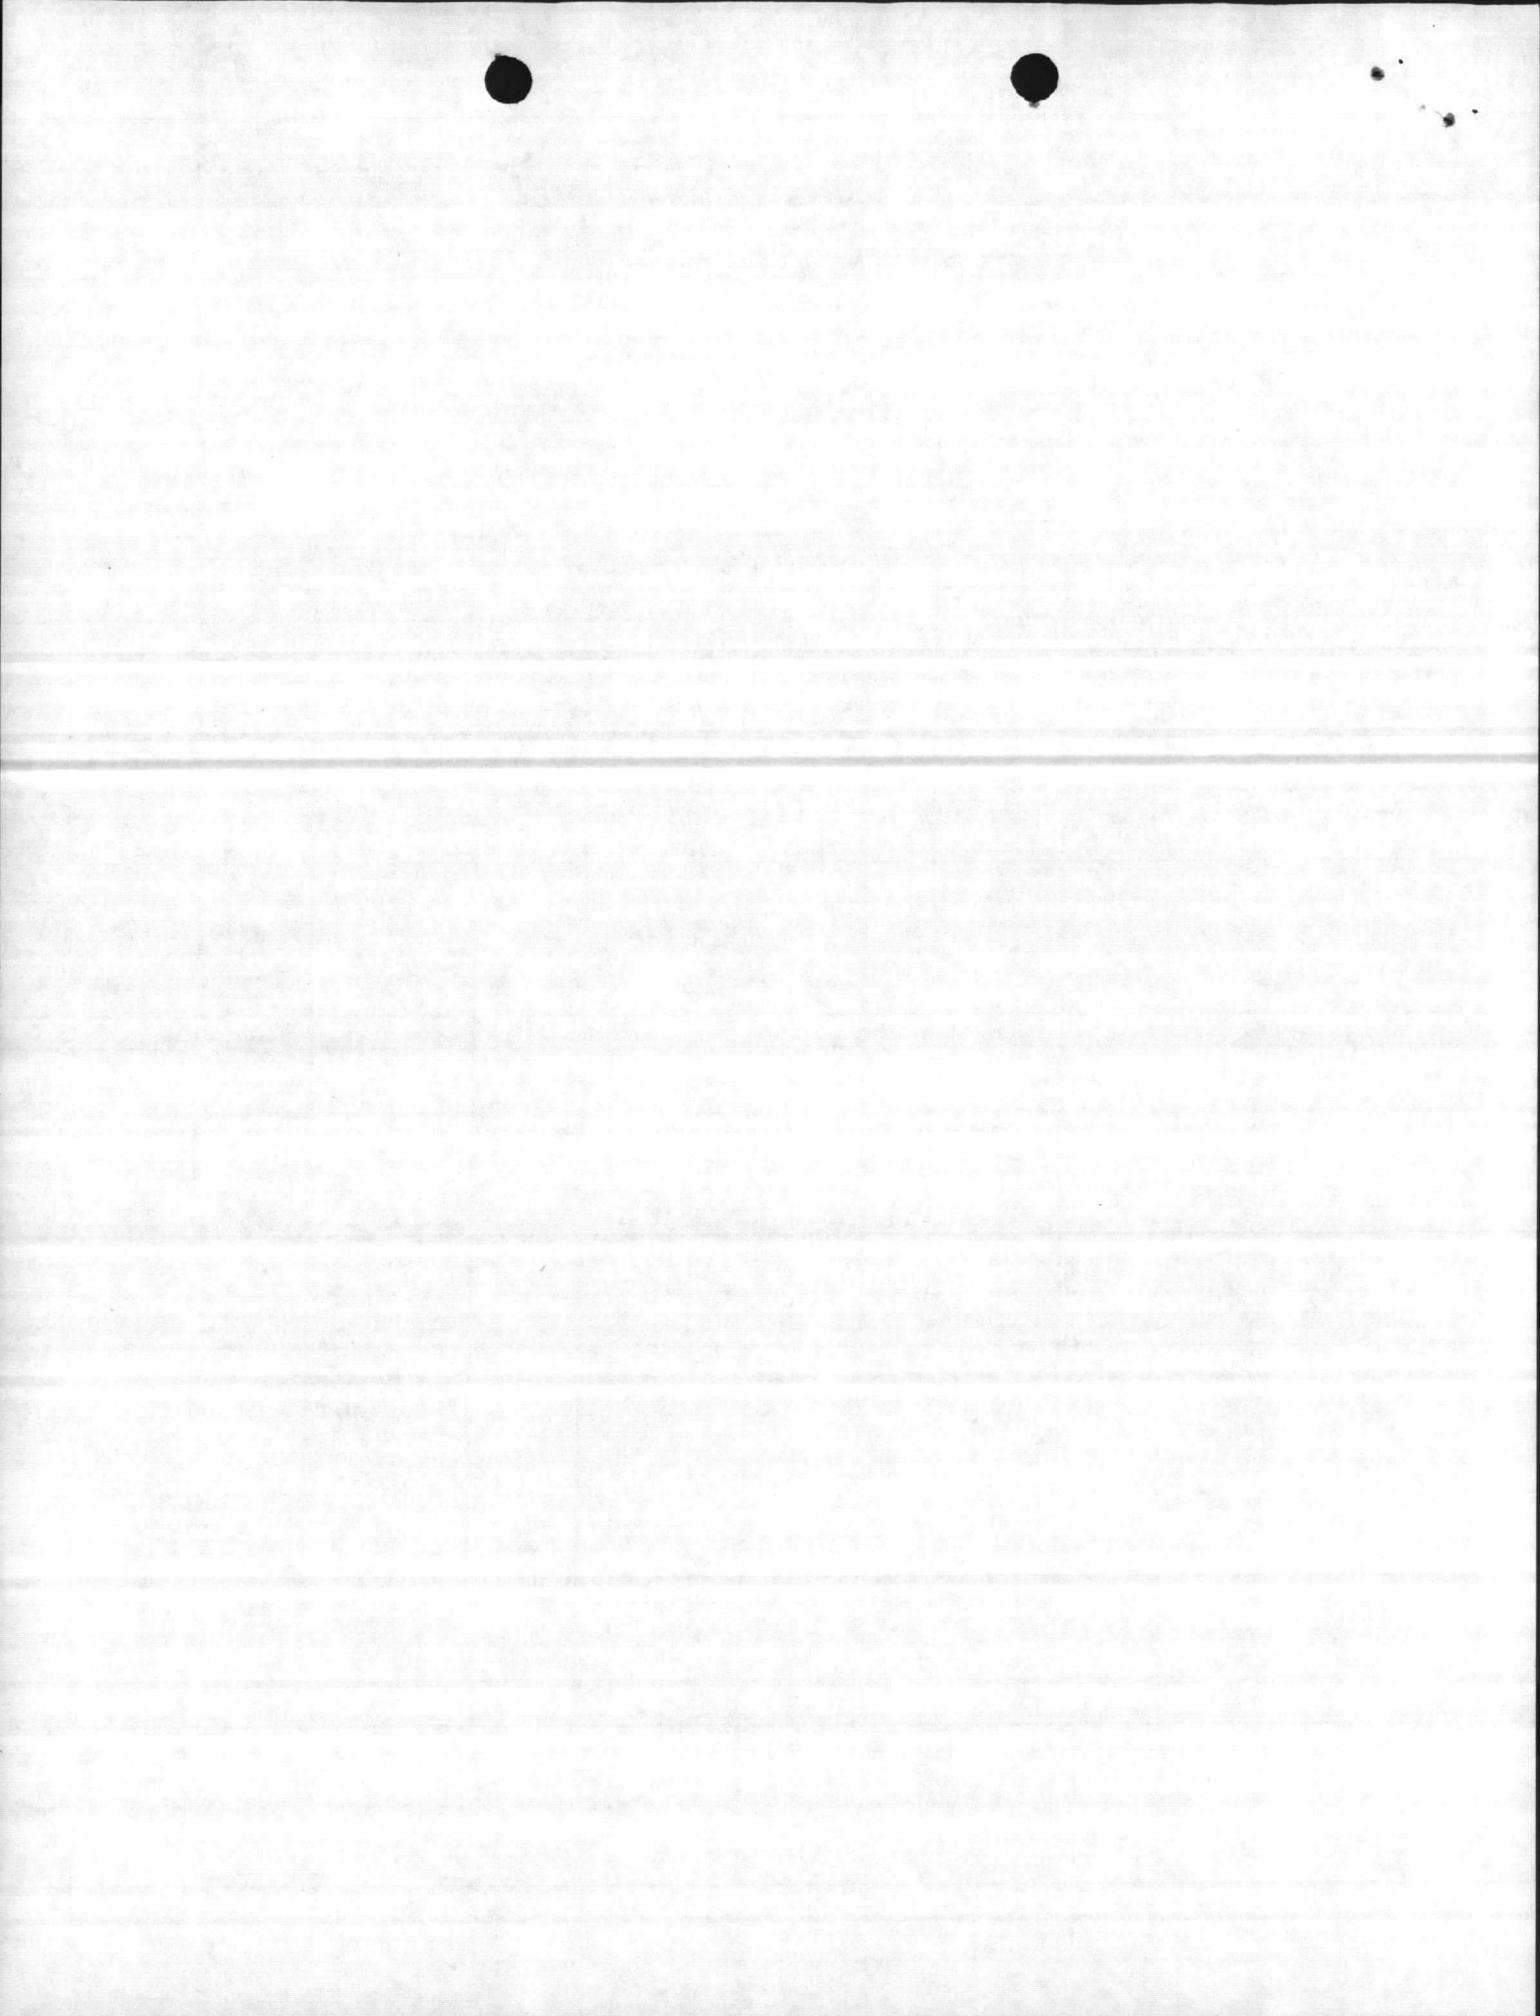


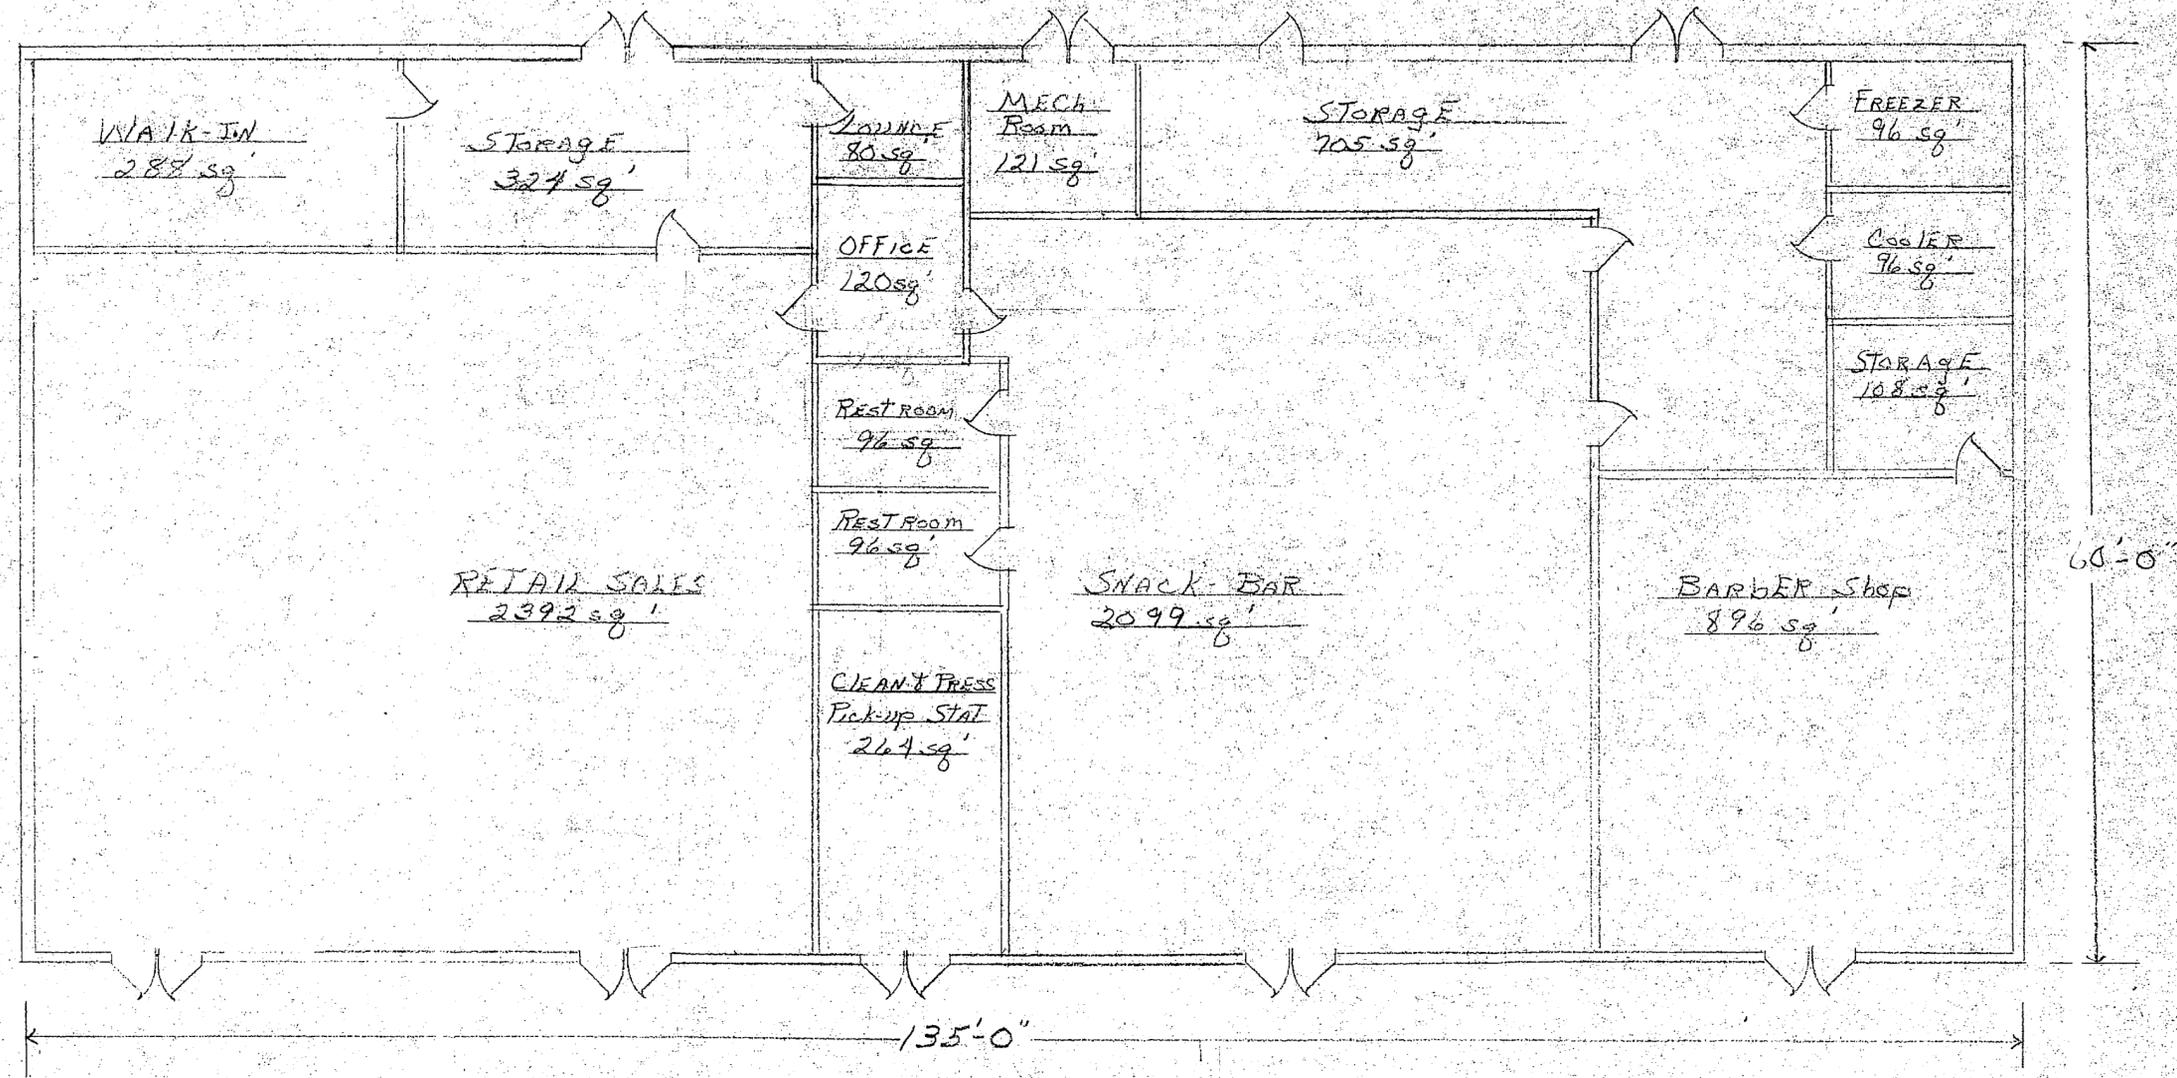

8100 sq' LOCATION EXCHANGE
SCALE: 1/8" = 1'-0"


P. W. DRAWING NO. 14019	MARINE CORPS. BASE CAMP LEJEUNE, NORTH CAROLINA
DES DRAWN TR CHK SU DIR. DES	LOCATION EXCHANGE HADNOT PT. 4 REA 1 & 2 FLOOR PLAN P-178
APPROV. FOR PUBLIC WORKS OFFICER	SUBMITTED COMMANDING GENERAL
DATE 9/8/78	SCALE SHEET 1 OF 1 C.D. DWG NO.



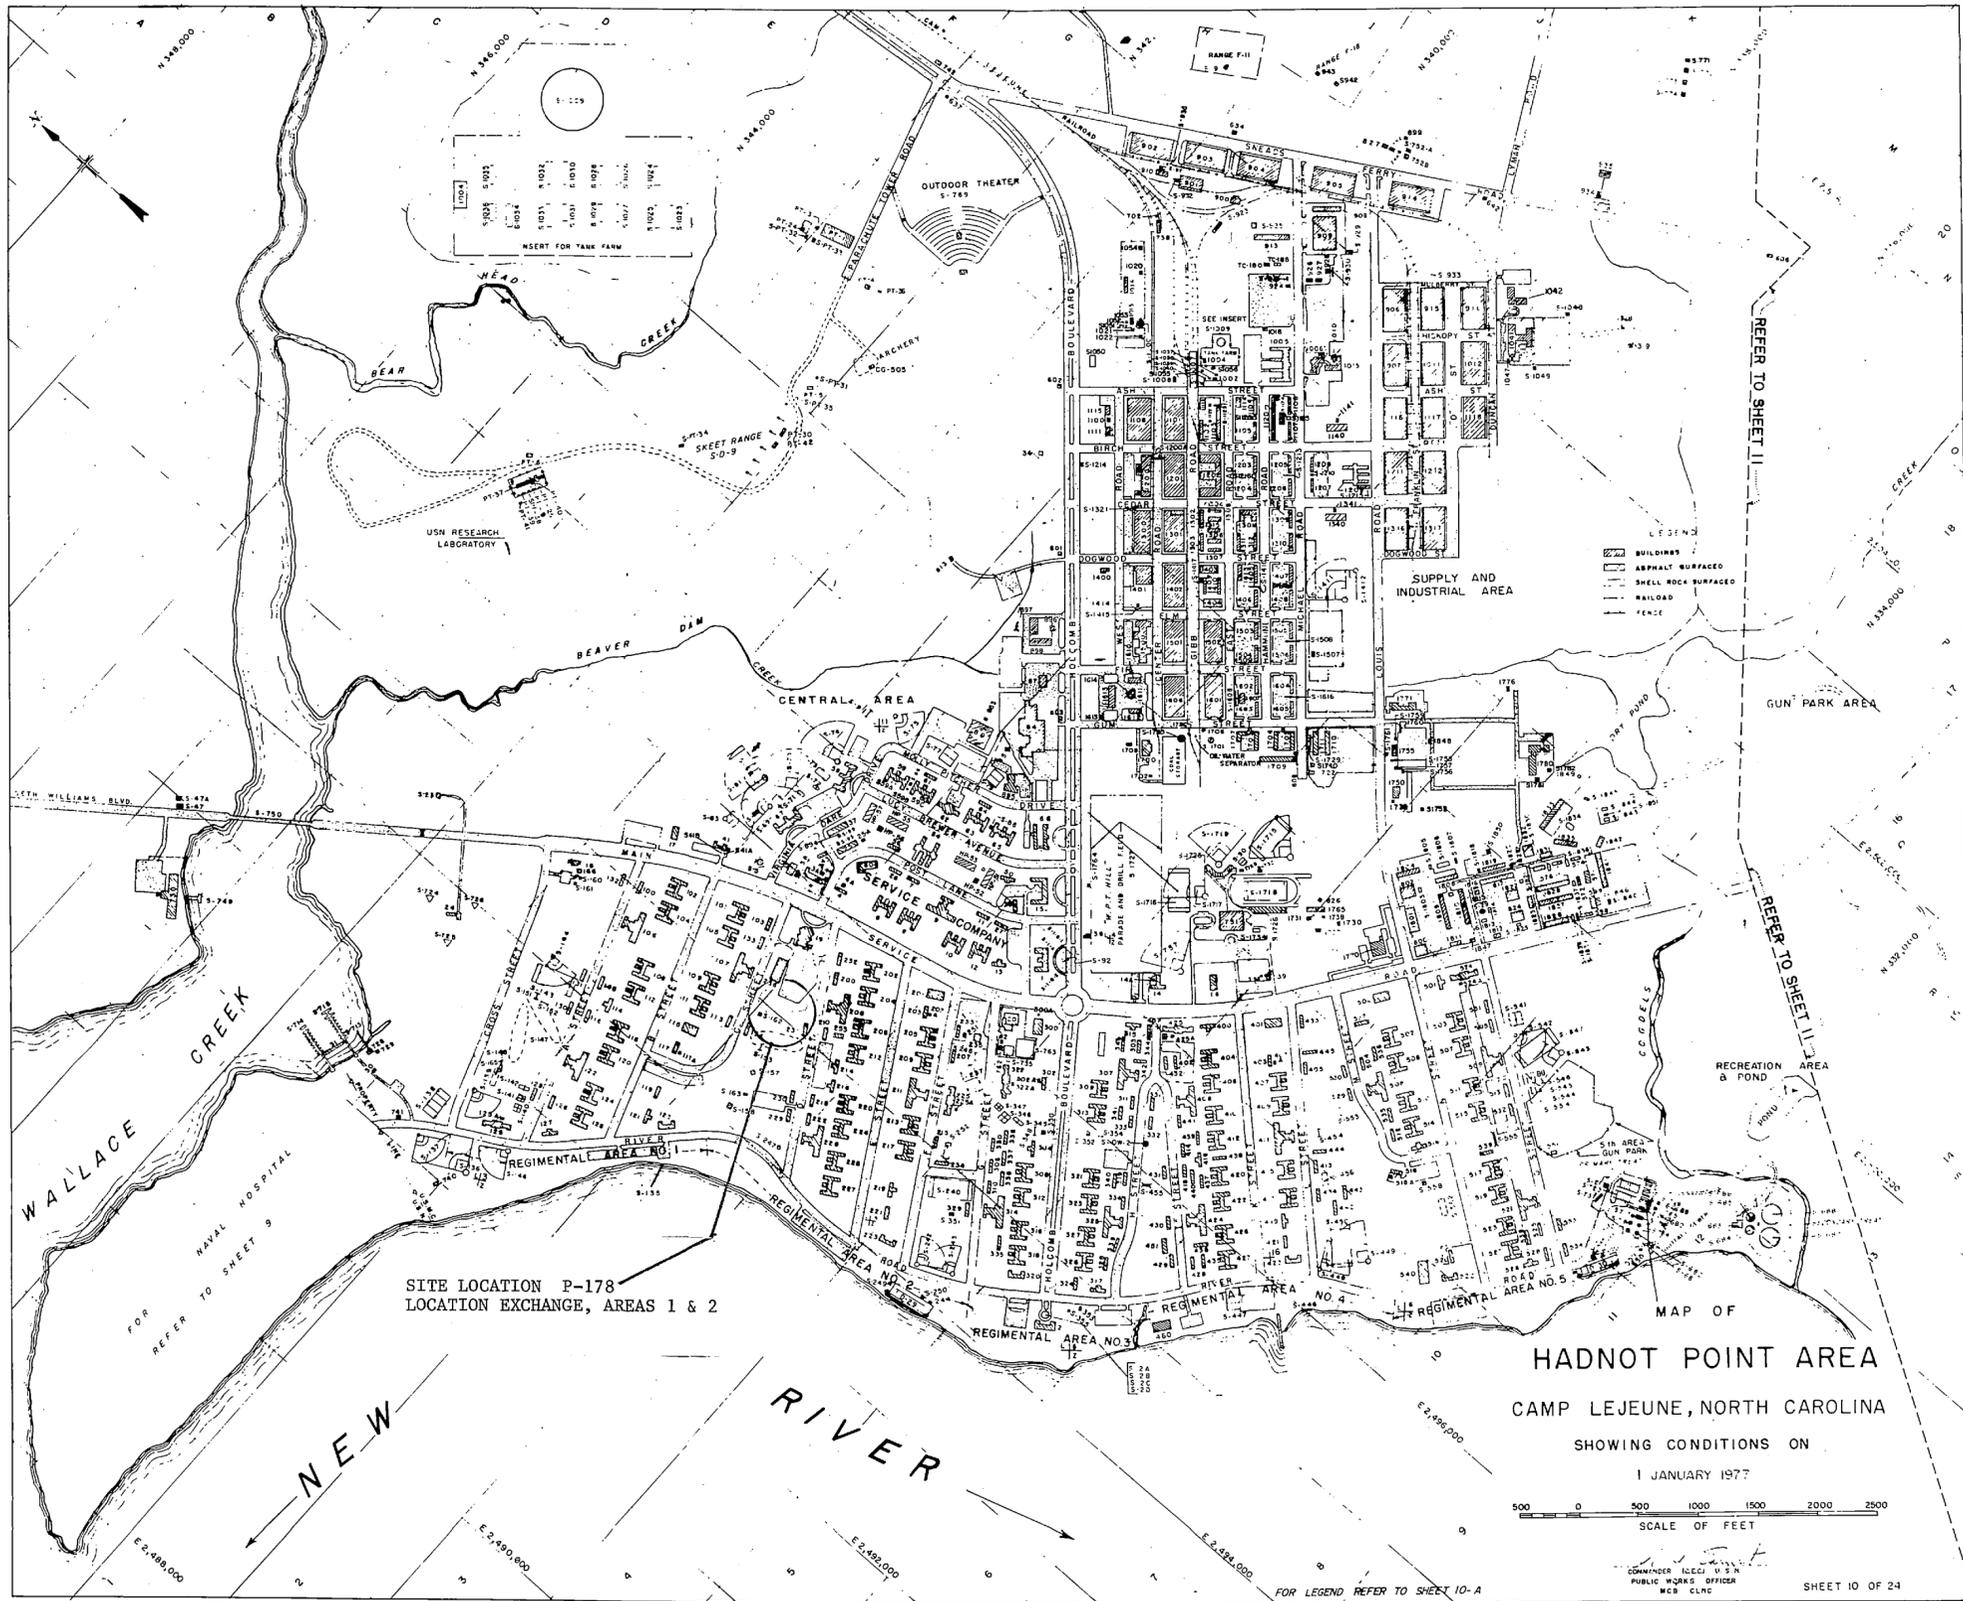

SITE LOCATION P-178
 LOCATION EXCHANGE, AREAS 1 & 2

MAP OF
HADNOT POINT AREA
 CAMP LEJEUNE, NORTH CAROLINA
 SHOWING CONDITIONS ON
 1 JANUARY 1977

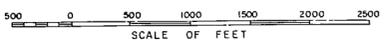

FOR LEGEND, REFER TO SHEET 10-A
 FOR OFFICIAL USE ONLY
 SHEET 10 OF 24
 CAMP LEJEUNE, N.C.

